Drain: OUERMAN - HARVEY	Drain #: 32
Improvement/Arm: YILLAGE OF	MT. CAN MEC . SECTION
Uperator: <u>المرابرالد المرابر</u>	Date:/
Drain Classification: Urban/Rura	Year Installed: 2003

# **GIS Drain Input Checklist**

•	Pull Source Documents for Scanning		wit
•	Digitize & Attribute Tile Drains	····	00
•	Digitize & Attribute Storm Drains		
•	Digitize & Attribute SSD		
•	Digitize & Attribute Open Ditch		
•	Stamp Plans		
•	Sum drain lengths & Validate		
•	Enter Improvements into Posse		fut
•	Enter Drain Age into Posse		
•	Sum drain length for Watershed in Posse		
•	Check Database entries for errors		



Kenton C. Ward, Surveyor Phone (317) 776-8495 Fax (317) 776-9628

Suite 188 One Hamilton County Square Noblesville, Indiana 46060-2230

To: Hamilton County Drainage Board

June 23, 2003

Re: Village of Mount Carmel, Section 10 Arm, Overman Harvey Drain

Attached is a petition filed by Elliott Wright Group along with a non-enforcement request, plans, calculations, quantity summary and assessment roll for the Village of Mount Carmel, Section 10 Arm, Overman Harvey Drain to be located in Clay Township. I have reviewed the submittals and petition and have found each to be in proper form.

I have made a personal inspection of the land described in the petition. Upon doing so, I believe that the drain is practicable; will improve the public health; benefit a public highway and be of public utility; and that the costs, damages, and expenses of the proposed drain will probably be less than the benefits accruing to the owners of land likely to be benefited. The drain will consist of the following:

6" SSD	850 ft	18" RCP	46 ft	30" RCP	747 ft
12" RCP	890 ft	21" RCP	122 ft		
15" RCP	242 ft	24" RCP	348 ft		

The total length of the drain will be 3,245 feet.

The retention pond (lake) located in Common Area "A" is to be considered part of the regulated drain. Only the inlet and outlet will be maintained as part of the regulated drain. The maintenance of the pond (lake) will be the responsibility of the Homeowners Association. The Board will however retain jurisdiction for ensuring the storage volume for which the lake was designed will be retained. Thereby, allowing no fill or easement encroachments.

The subsurface drains (SSD) to be part of the regulated drain are those located under curbs. Only the main SSD lines which are located within the right of way are to be maintained as regulated drain. Laterals for individual lots will not be considered part of the regulated drain.

I have reviewed the plans and believe the drain will benefit each lot equally. Therefore, I recommend each lot be assessed equally. I also believe that no damages will result to landowners by the construction of this drain. I recommend a maintenance assessment of \$3.00 per acre for common areas and platted lots, \$3.00 per acre for roadways, with a \$30.00 minimum. With this assessment the total annual assessment for this drain/this section will be \$240.00.

The petitioner has submitted surety for the proposed drain at this time. Surety shall be submitted prior to the approval of the Hamilton County Board of Commissioners/commencement of construction. The sureties, which are in the form of a Performance Bond/Letter of Credit are as follows:

Agent: Bond Safeguard Insurance Company

Date: April 25, 2003 Number: 5004799 For: Storm Drain Amount: \$62,973.80

Parcels assessed for this drain may be assessed for the Wheeler & Beals or Cool Creek Drain at sometime in the future.

I believe this proposed drain meets the requirements for Urban Drain Classification as set out in IC 36-9-27-67 to 69. Therefore, this drain shall be designated as an Urban Drain.

I recommend that upon approval of the above-proposed drain that the Board also approve the attached non-enforcement request. This request is for the reduction of the regulated drain easement to those easement widths as shown on the secondary plat for Village of Mount Carmel Section 10 as recorded in the office of the Hamilton County Recorder.

Also to be included are portions of the storm sewer system installed with the improvements of 146<sup>th</sup> Street. Village of Mount Carmel Section 10 utilizes this system as its outlet. This system is shown on Sheets 6 and 7 of the plans prepared by American Consulting Engineers, Inc. for Hamilton County. This is for project HCHD PR-97-0006 and the plans are file stamped March 18, 1999. This portion of the drain shall consist of those structures and portions of drain between the following structures:

Str. 37 to 33; Str. 36 to 34; Str. 34A to 34; Str. 35 to 34; Str. 34 to 32; Str. 31 to 32; Str. 30 to 32; Str. 32 to 33; Str. 27 to 28; Str. 28 to 29; Str. 33 to 29; Str. 29 to 24; Str. 26 to 23; Str. 25 to 22; Str. 22 to 23; Str. 23 to 24; Str. 24 to 21; Str. 15 to 16; Str. 16 to 17; Str. 17 to Outlet.

Structure 21 connects the system with the existing regulated drain which was constructed as Village Farms Section 18 Arm to the Overman-Harvey Drain. This portion of the system is a 30" RCP which outlets into the lake for Village Farms.

Also to be a portion of the drain are the pair of inlets and pipe sections installed at Adios Pass along the south right of way for 146<sup>th</sup> Street in the Village of Mount Carmel Section 8. This is the portion between Str. 12 to Str. 13 and Str. 13 to Str. 14.

I recommend the Board set a hearing for this proposed drain for July 28, 2003.

Kenton C. Ward

Hamilton County Surveyor

KCW/llm

STATE OF INDIANA )
COUNTY OF HAMILTON )

TO: HAMILTON COUNTY DRAINAGE BOARD

% Hamilton County Surveyor, Courthouse, Noblesville, IN 46060

In the matter of Vilage of Mount Carmle Subdivision,

Section Ten (10) Drain Petition.

Petitioner is the owner of all lots in the land affected by the proposed new regulated drain. The drainage will affect various lots in Village of Mount Carmel , a subdivision in Hamilton County, Indiana. The general route of such drainage shall be in existing easements and along public roads as shown in the plans on file in the Surveyor's Office.

Petitioner believes that the cost, damages and expenses of the proposed improvement will be less than the benefits which will result to the owners of the land likely to be benefited thereby. Petetioner believes the proposed improvements will:

- (a) improve public health
- (b) benefit a public street
- (c) be of public utility

Petitioner agrees to pay the cost of construction of the drainage system and requests periodic maintenance assessments by the Board thereafter.

The Petitioner also agrees to the following:

- 1. To provide the Drainage Board a Performance Bond for the portion of the drainage system which will be made a regulated drain. The bond will be in the amount of 100% of the Engineers estimate. The bond will be in effect until construction of 100% of the system is completed and so certified by the Engineer.
- 2. The Petitioner shall retain an Engineer throughout the construction phase. At completion of the project the Petitioner's Engineer shall certify that the drainage system which is to be maintained as a regulated drain has been constructed as per construction plans.

- 3. The Petitioner agrees to request in writing to the County Surveyor any changes from the approved plan and must receive written authorization from the County Surveyor prior to implementation of the change. All changes shall be documented and given to the Surveyor to be placed in the Drain File.
- 4. The Petitioner shall instruct his Engineer to provide a reproducable print on a 24" x 36" mylar of the final design of the Drainage System. This shall be submitted to the County Surveyor prior to the release of the Performance Bond.
- The Petitioner shall comply with the Erosion Control Plan as as specified on the construction plans. Failure to comply with the Erosion Control Plan shall be determined by the Board as being an obstruction to the drainage system. The County Surveyor shall immediately install or repair the needed measures at Petitioners cost as per IC 36-9-27-46.

The Petitioner further requests that the Drain be classified as an Urban Drain.

1,

Signed

Parvin C. Wright

Printed Name

Signed

<u> William B. Elliott</u>

Printed Name

RECORDED OWNER(S) OF LAND INVOLVED

DATE April 16, 2003

APR 2 2 2003

OFFICE OF HAMILTON COUNTY SURVEYOR

### FINDINGS AND ORDER

### CONCERNING THE MAINTENANCE OF THE

Overman Harvey Drain, Village of Mount Carmel Section 10 Arm

On this 28th day of July, 2003, the Hamilton County Drainage Board has held a hearing on the Maintenance Report and Schedule of Assessments of the Overman Harvey Drain, Village of Mount Carmel Section 10 Arm.

Evidence has been heard. Objections were presented and considered. The Board then adopted the original/amended Schedule of Assessments. The Board now finds that the annual maintenance assessment will be less than the benefits to the landowners and issues this order declaring that this Maintenance Fund be established.

HAMILTON COUNTY DRAINAGE BOARD

President

Member

Member

Attest: Lynette Mosboug

HCDB- 2003-003 | SUBDIVISION PERFORMANCE BOND

	Bond #_5004799
KNOW ALL MEN BY THESE PRESENTS, that we Cross Wright Group, 599 Industrial Drive, Suite 318, Carr	manife days
Wright Group, 599 Industrial Drive, Suite 318, Carras Principal and Bond Safeguard Town	mal IN Acons
as Principal, and Bond Safeguard Transport	919 C Tickle
Bldg. A, Lombard, IL 60148	713 S. Highland Avenue, Suite 300,
authorized to do business in the State of <u>Indiana</u> Hamilton County Surveyor, One Hamilton Square, Sui	on County and I I I County
Hamilton County Surveyor, One Hamilton Square, Sur as Obligee, in the penal sum of Sixty Two Thousand wine	, as surery are held firmly bound unto
as Congee, in the penal sum of Sixty Two Thousand Nine	Hundred Coverts at
for the payment of which sum well and truly to be made and truly	Three and 80/100
executors, successors and assigns, jointly and severally firmly	by these present;
WHEREAS, the above bounden Principal has been granted apprinted of Mount Carmel, Section 10, Storm Drainage	•
NOW, THEREFORE, the condition of the obligation is such, the above improvements in accordance with the plans and specification.	arroug Frehared DA
from all costs and damages which it may suffer by reason of fairepay Obligee any outlay and expense which it may incur in ma obligation shall be null and void, otherwise to remain in full for	ilure to do so, and fully reimburse and sking good any such default, then this ree and effect.
THE FOREGOING OBLIGATION, however, is limited by the performance of which shall be a condition precedent to any right	us of claurs of recovery hereunder:
1. Upon the discovery by the Obligee, or by the Obligee's a omission that shall or might involve a loss hereunder, the Oblige thereof with the fullest information obtainable at the time to the	agent or representative, of any act or
<ol> <li>Legal proceedings for recovery hereunder may not be bromonths from the date of the discovery of the act or omission of the made.</li> </ol>	ought unless begun within twelve (12) the Princ pal on account of which claim is
3. The Principal shall be made a party to any suit or action fehall be rendered against the Surety in excess of the penalty of the	for recovery hereunder, and no judgment is instrument.
No right of action shall accrue hereunder to or for the use obligee, and the Obligee's right hereunder may not be assigned value.	or benefit of anyone other than the without the written consent of the Surety.
Crossmark Construction, Inc. and	
y: Kayser ( Suidan ) By:_	Delan M. Brek
	eboran M. Roth , Attorney-in-Fact

### CERTIFICATE OF COMPLETION AND COMPLIANCE

To: Hamilton County Surveyor

Re: Village of Mt. Carmel Tenth Section
I hereby certify that:
1. I am a Registered <b>************************************</b>
2. I am familiar with the plans and specifications for the above referenced subdivision.
3. I have personally observed and supervised the completion of the drainage facilities for the above referenced subdivision.
4. The drainage facilities within the above referenced subdivision to the best of my knowledge, information and belief have been installed and completed in conformity with all plans and specifications.
Signature: Date: 12-15-03
Type or Print Name: James Shinneman
Business Address: Weihe Engineers, Inc.
10505 N. college Ave., Indianapolis, IN 46280
Telephone Number: 317-846-6611
SEAL INDIANA REGISTRATION NUMBER 10200392







Kenton C. Ward, Surveyor Phone (317) 776-8495 Fax (317) 776-9628

Suite 188 One Hamilton County Square Noblesville, Indiana 46060-2230

To: Hamilton County Drainage Board

October 14, 2005

Re: Overman-Harvey Drain: Village of Mt. Carmel Section 10 & 146<sup>th</sup> St. Offsite

Attached are as-builts, certificate of completion & compliance, and other information for Village of Mt. Carmel. An inspection of the drainage facilities for this section has been made and the facilities were found to be complete and acceptable.

During construction, changes were made to the drain, which will alter the plans submitted with my report for this drain-dated June 23, 2003. The report was approved by the Board at the hearing held July 28, 2003. (See Drainage Board Minutes Book 7, Pages 119-121) The changes are as follows:

				Up		
Structure:	Length:	Size	Material:	Invert:	Dn_Invert	Grade:
13-12	221	12	RCP	881.87	881.1	0.4
12-11	148	12	RCP	881.1	880.43	0.45
11-10	143	15	RCP	880.43	879.87	0.39
10-9	48	15	RCP	879.87	879.5	0.77
8-7	266	15	RCP	880.87	880.21	0.25
7-6	24	15	RCP	880.21	880.01	0.83
6-5	56	15	RCP	880.01	879.55	0.82
3-2	122	21	RCP	879.83	879.43	0.33
2-4	51	15	RCP	879.43	879.42	0.02
2-1	250	24	RCP	879.43	878.4	0.41
15-14	24	12	RCP	882.23	881.33	0.38
14-11	23	12	RCP	881.33	880.43	3.91
33-29	26	30	RCP	876.8	876.72	
29-24	459	30	RCP	876.62	875.11	
24-503*	262	30	RCP	875	874.16	
32-33	94	30	RCP			
27-28	66	12	RCP			
29-29	9	12	RCP			
37-33	75	12	RCP			
36-34	35	12	RCP			
34-32	56	18	RCP			
35-34	7	12	RCP			

1-32	15	24	RCP		
15-16	65	12	RCP		
16-17	63	12	RCP		
17-End of Pipe	16	12	RCP		
25-22	15	12	RCP		
22-23	68	12	RCP		
26-23	17	12	RCP		
23-24	13	12	RCP		
* Was structure 21					

6" SSD

Streets: 522.5

**TotalX2:** 1045

**RCP Pipe Totals:** 

NOT FIRE I Utals.					
12	865				
15	588				
18	56				
21	122				
24	265				
30	841				

**Total:** 2737

The length of the drain due to the changes described above is now 3,782 feet. This footage is for Village of Mt. Carmel Section 10 and the offsite constructed with 146<sup>th</sup> St. It should be noted that this does not include those facilities constucted across Adios Pass (Village of Mt. Carmel Sec. 8). These structures (12,13,14) were addressed in the final report given to the Board for 146<sup>th</sup> St. dated June 13, 2005. The attached plans for 146<sup>th</sup> Street do reflect all the information that is listed above. This information was obtained through a field investigation.

The non-enforcement was approved by the Board at its meeting on July 28, 2003 and recorded under instrument #200300093799.

The following sureties were guaranteed by Bond Safeguard Insurance Co and released by the Board on its September 12, 2005 meeting.

**Bond-LC No:** 5004799 **Insured For:** Storm Sewers

**Amount:** \$62,973.80 **Issue Date:** April 25, 2003

I recommend the Board approve the drain's construction as complete and acceptable.

Sincerely,

Kenton C. Ward,

Hamilton County Surveyor

### Gasb 34 Asset Price & Drain Length Log


Drain-Improvement: Overman-Hawey Drain: Village of Mt. Carmel - 146th St. Extsite

						If App	licable
Orain Type:		Size:	Length	Length (DB Query)	Length Reconcile	Price:	Cost:
	RCP	رح"	449'	449'	Ø	#735 IF	32 <i>55</i>
	RLP	1B"		56'	Ø	# 1050 IF	<b>#</b> 588 ∞
	RLP	24"	56' 15'	15'	Ø	# 1800 H	# 270°
	RCP	30"	841'	841'	Ø	# 24 w ff	* 270 ° 270 ° 20,688 ° 4
				,			
		, ,					
		Sum:	1361	136)			# 24,801°
Final Report:_ Comments:			1997 141.	K & T	calaman t	·c	
Constructe	d as pour	t of the	1997 146	K S. Tup	ovement		
		<del></del> -					

# CONSTRUCTION PLANS FOR VILLAGE OF MOUNT CARMEL TENTH SECTION VILLAGE DRIVE NORTH CARMEL, INDIANA

# PLANS PREPARED FOR:

ELLIOTT WRIGHT GROUP 597 INDUSTRIAL DRIVE, SUITE 104 CARMEL, INDIANA 46032 TELEPHONE: (317) 846-3798 FAX: (317) 846-3796 CONTACT PERSON: CHUCK WRIGHT

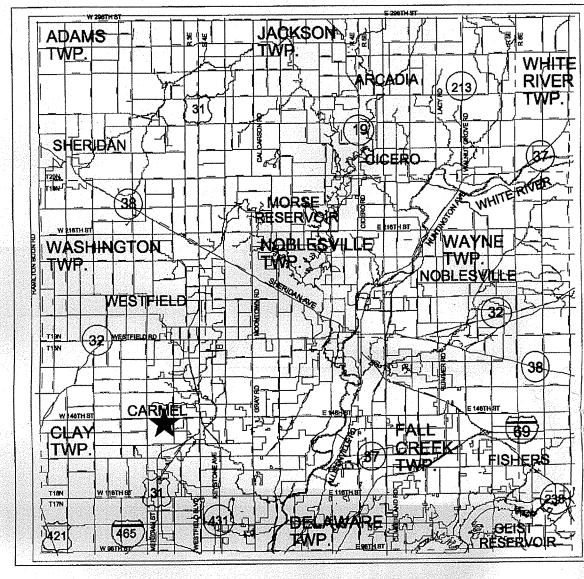

AREA MAP \* PROJECT LOCATION


# PLANS PREPARED BY:

WEIHE ENGINEERS, INC. 10505 N. COLLEGE AVE. INDIANAPOLIS, IN 46280 TELEPHONE: (317) 846-6611 FAX: (317) 843-0546 CONTACT PERSON: DARRELL PHILLIPS



SITE LOCATION MAP \* PROJECT LOCATION

Call 1-800-382-5544 2 WORKING DAYS BEFORE YOU DIG.

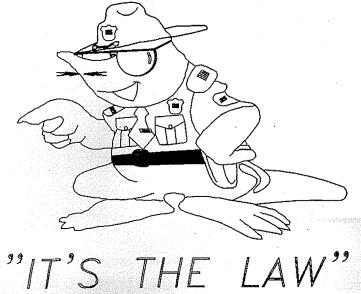

INDIANA UNDERGROUND PROTECTION SERVICE, INC.

INDIANA STATE DEPARTMENT OF TRANSPORTATION STANDARD SPECIFICATIONS LATEST EDITION TO BE USED WITH THESE PLANS.

## BENCHMARK

RAILROAD SPIKE IN THE SOUTH SIDE OF A POWER POLE PER AMERICAN CONSULTING ENGINEERS SURVEY CONTROL PLAT FOR 146TH STREET (JOB 97-614). (TBM #28) ELEVATION = 884.33 (NAVD 1988)

# TEMPORARY BENCHMARK

THE NORTHWEST BASE BOLT ON A LIGHT STANDARD ON THE EAST SIDE OF AN ASPHALT DRIVE AT OUR LADY OF MOUNT CARMEL CATHOLIC CHURCH, BEING DIRECTLY EAST OF THE BUILDING, AND APPROXIMATELY 20 FEET SOUTH OF A 21" MAPLE TREE. (ESTABLISHED IN WEIHE ENGINEERS, INC. JOB W00-895) ELEVATION = 883.60

# **GENERAL NOTES:**

1) THE CONTRACTOR SHALL BE RESPONSIBLE FOR OBTAINING, OR VERIFYING THAT ALL PERMITS AND APPROVALS ARE OBTAINED FROM THE RESPECTIVE CITY, COUNTY, AND STATE AGENCIES PRIOR TO STARTING CONSTRUCTION.

2) IT SHALL BE THE CONTRACTORS RESPONSIBILITY TO DETERMINE THE EXACT LOCATION OF ALL EXISTING UTILITIES IN THE VICINITY OF THE CONSTRUCTION AREA PRIOR TO STARTING CONSTRUCTION

3) IT SHALL BE THE CONTRACTORS RESPONSIBILITY TO NOTIFY AND COORDINATE CONSTRUCTION WITH ALL RESPECTIVE UTILITIES.

4) ALL QUANTITIES GIVEN ON THESE PRINTS, VERBALLY OR IN THE SCOPE OF WORK SECTION ARE ESTIMATES AND SHALL BE CONFIRMED BY THE BIDDING

5) OCCUPATIONAL SAFETY AND HEALTH ADMINISTRATION (OSHA) STANDARDS FOR EXCAVATIONS: FINAL RULE 29 CFR PART 1926, SUBPART "P" APPLIES TO ALL EXCAVATIONS EXCEEDING FIVE (5) FEET IN DEPTH. 6) IN ADDITION, EXCAVATION EXCEEDING TWENTY (20) FEET IN DEPTH REQUIRE

THE DESIGN OF A TRENCH SAFETY SYSTEM BY A REGISTERED PROFESSIONAL 7) IT SHALL BE THE RESPONSIBILITY OF THE DEVELOPER AND CONTRACTOR TO

8) TEMPORARY TRAFFIC CONTROL DURING CONSTRUCTION TO CONFORM TO APPLICABLE LOCAL STANDARDS.


9) ANY FIELD TILES ENCOUNTERED DURING EXCAVATION SHALL BE REPAIRED AND CONNECTED TO NEW STORM SEWERS AND POSITIVE DRAINAGE PRESERVED.

MAINTAIN QUALITY CONTROL THROUGHOUT THIS PROJECT.

10) THE DESCRIBED REAL ESTATE DOES NOT LIE WITHIN A SPECIAL FLOOD HAZARD ZONE AS PLOTTED BY SCALE ON THE FEDERAL EMERGENCY MANAGEMENT AGENCY, NATIONAL FLOOD INSURANCE PROGRAM, FIRM FLOOD INSURANCE RATE MAP COMMUNITY-PANEL NUMBER 180081 0207 F, DATED FEBRUARY 19, 2003.

11) BEARINGS, DIMENSIONS AND EASEMENTS ARE SHOWN FOR REFERENCE ONLY. SEE RECORD SURVEYS & PLAT FOR EXACT INFORMATION.

13) WETLANDS ARE NOT SHOWN ON THE U.S. DEPARTMENT OF THE INTERIOR FISH AND WILDLIFE SERVICE: CARNEL IND, NATIONAL WETLANDS INVENTORY MAP

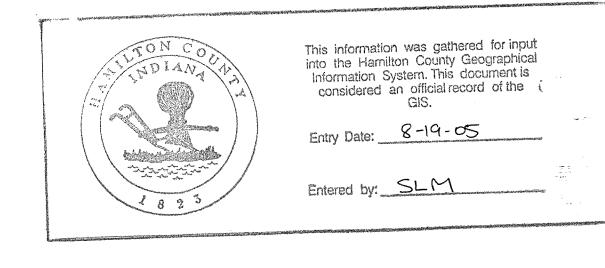

# INDEX

SHEET NO.	DESCRIPTION
1	TITLE SHEET
2	EXISTING CONDITIONS/DEMOLITION PLAN
3	SITE DEVELOPMENT PLAN
4	STREET PLAN AND PROFILE
5	STORM PLAN AND PROFILE
. 6	STORM PLAN AND PROFILE
7	SANITARY PLAN AND PROFILE
8	EROSION CONTROL PLAN
9	EROSION CONTROL DETAIL SHEET
10	SITE WATER PLAN
11	SITE CONSTRUCTION DETAILS
12	SPECIFICATIONS SHEET
d	

10200392 STATE OF

AMES K. SHINNEMAN P.E. 1020

SHEET NO.

PROJECT NO.

W02 - 0740



# REVISIONS

_	10271210172						
	SHEET NO.	DESCRIPTION	DATE				
	1,3,5,6,7,10	STORM SEWER, SANITARY SEWER & WATER LINE AS-BUILTS	12/15/03				
	***************************************						

This copy is from the Digital Archive of the Hamilton County Surveyor's Office; One Hamilton Co. Square, Ste. 188, Noblesville, In

RECORD DRAWING

INDIANA GAS COMPANY

POST OFFICE BOX 1700

NOBLESVILLE IN 46060

OFFICE OF FIRE CHIEF

2 CIVIC SQUARE

3 CIVIC SQUARE

CARMEL, IN 46032

31 FIRST AVE. N.W.

CARMEL, IN 46032

TELEPHONE: (317) 776-5597

INDIANAPOLIS, INDIANA 46220

TELEPHONE: (317) 571-2600

CARMEL POLICE DEPARTMENT

TELEPHONE: (317) 571-2500

INDIANAPOLIS, IN 46206-1595

TELEPHONE: (317) 773-1872

TELEPHONE: (317) 571-2580

18100 CUMBERLAND ROAD

HAMILTON CO. SHERIFF DEPARTMENT

CARMEL COMMUNICATIONS DEPARTMENT

OPERATING AUTHORITIES:

CARMEL/CLAY SCHOOLS

CARMEL, IN 46032

1 CIVIC SQUARE

CARMEL, IN 46032

5201 EAST 131ST STREET

OFFICE OF CITY ENGINEER

1441 SOUTH GUILFORD

CARMEL, IN 46032

1 CIVIC SQUARE

CITY OF CARMEL

CARMEL, IN 46032

130 FIRST AVE. S.W.

130 FIRST AVE. S.W.

CARMEL, IN 46032

CARMEL, IN 46032

CITY OF CARMEL

TELEPHONE: (317) 844-9961

TELEPHONE: (317) 571-2414

TELEPHONE: (800) 521-2232

TELEPHONE: (317) 848-7275

WATER-WASTEWATER UTILITIES

TELEPHONE: (317) 571-2648

WATER-WASTEWATER UTILITIES

TELEPHONE: (317) 716-3943

PAT RIGDON - SEWER INSPECTOR

CARMEL CLAY PARKS & RECREATION

RECORD DRAWING
WATER AS-BUILTS
WATER STRUCTURES ONLY
12/15/03

RECORD DRAWNG
STORM SEWER AS-BUILTS
STORM SEWER STRUCTURES ONLY

HAMILTON COUNTY SURVEYOR

TELEPHONE: (317) 776-8495

925 DIVISION STREET, ROOM 301

TELEPHONE: (317) 773-1432

TELEPHONE: (317) 773-7770

NOBLESVILLE IN 46060

NOBLESVILLE IN 46060


1717 PLEASANT STREET

NOBLESVILLE IN 46060

ONE HAMILTON COUNTY SQUARE, SUITE 146

HAMILTON COUNTY HIGHWAY DEPARTMENT

HAMILTON COUNTY SOIL & WATER CONSERVATION DISTRICT

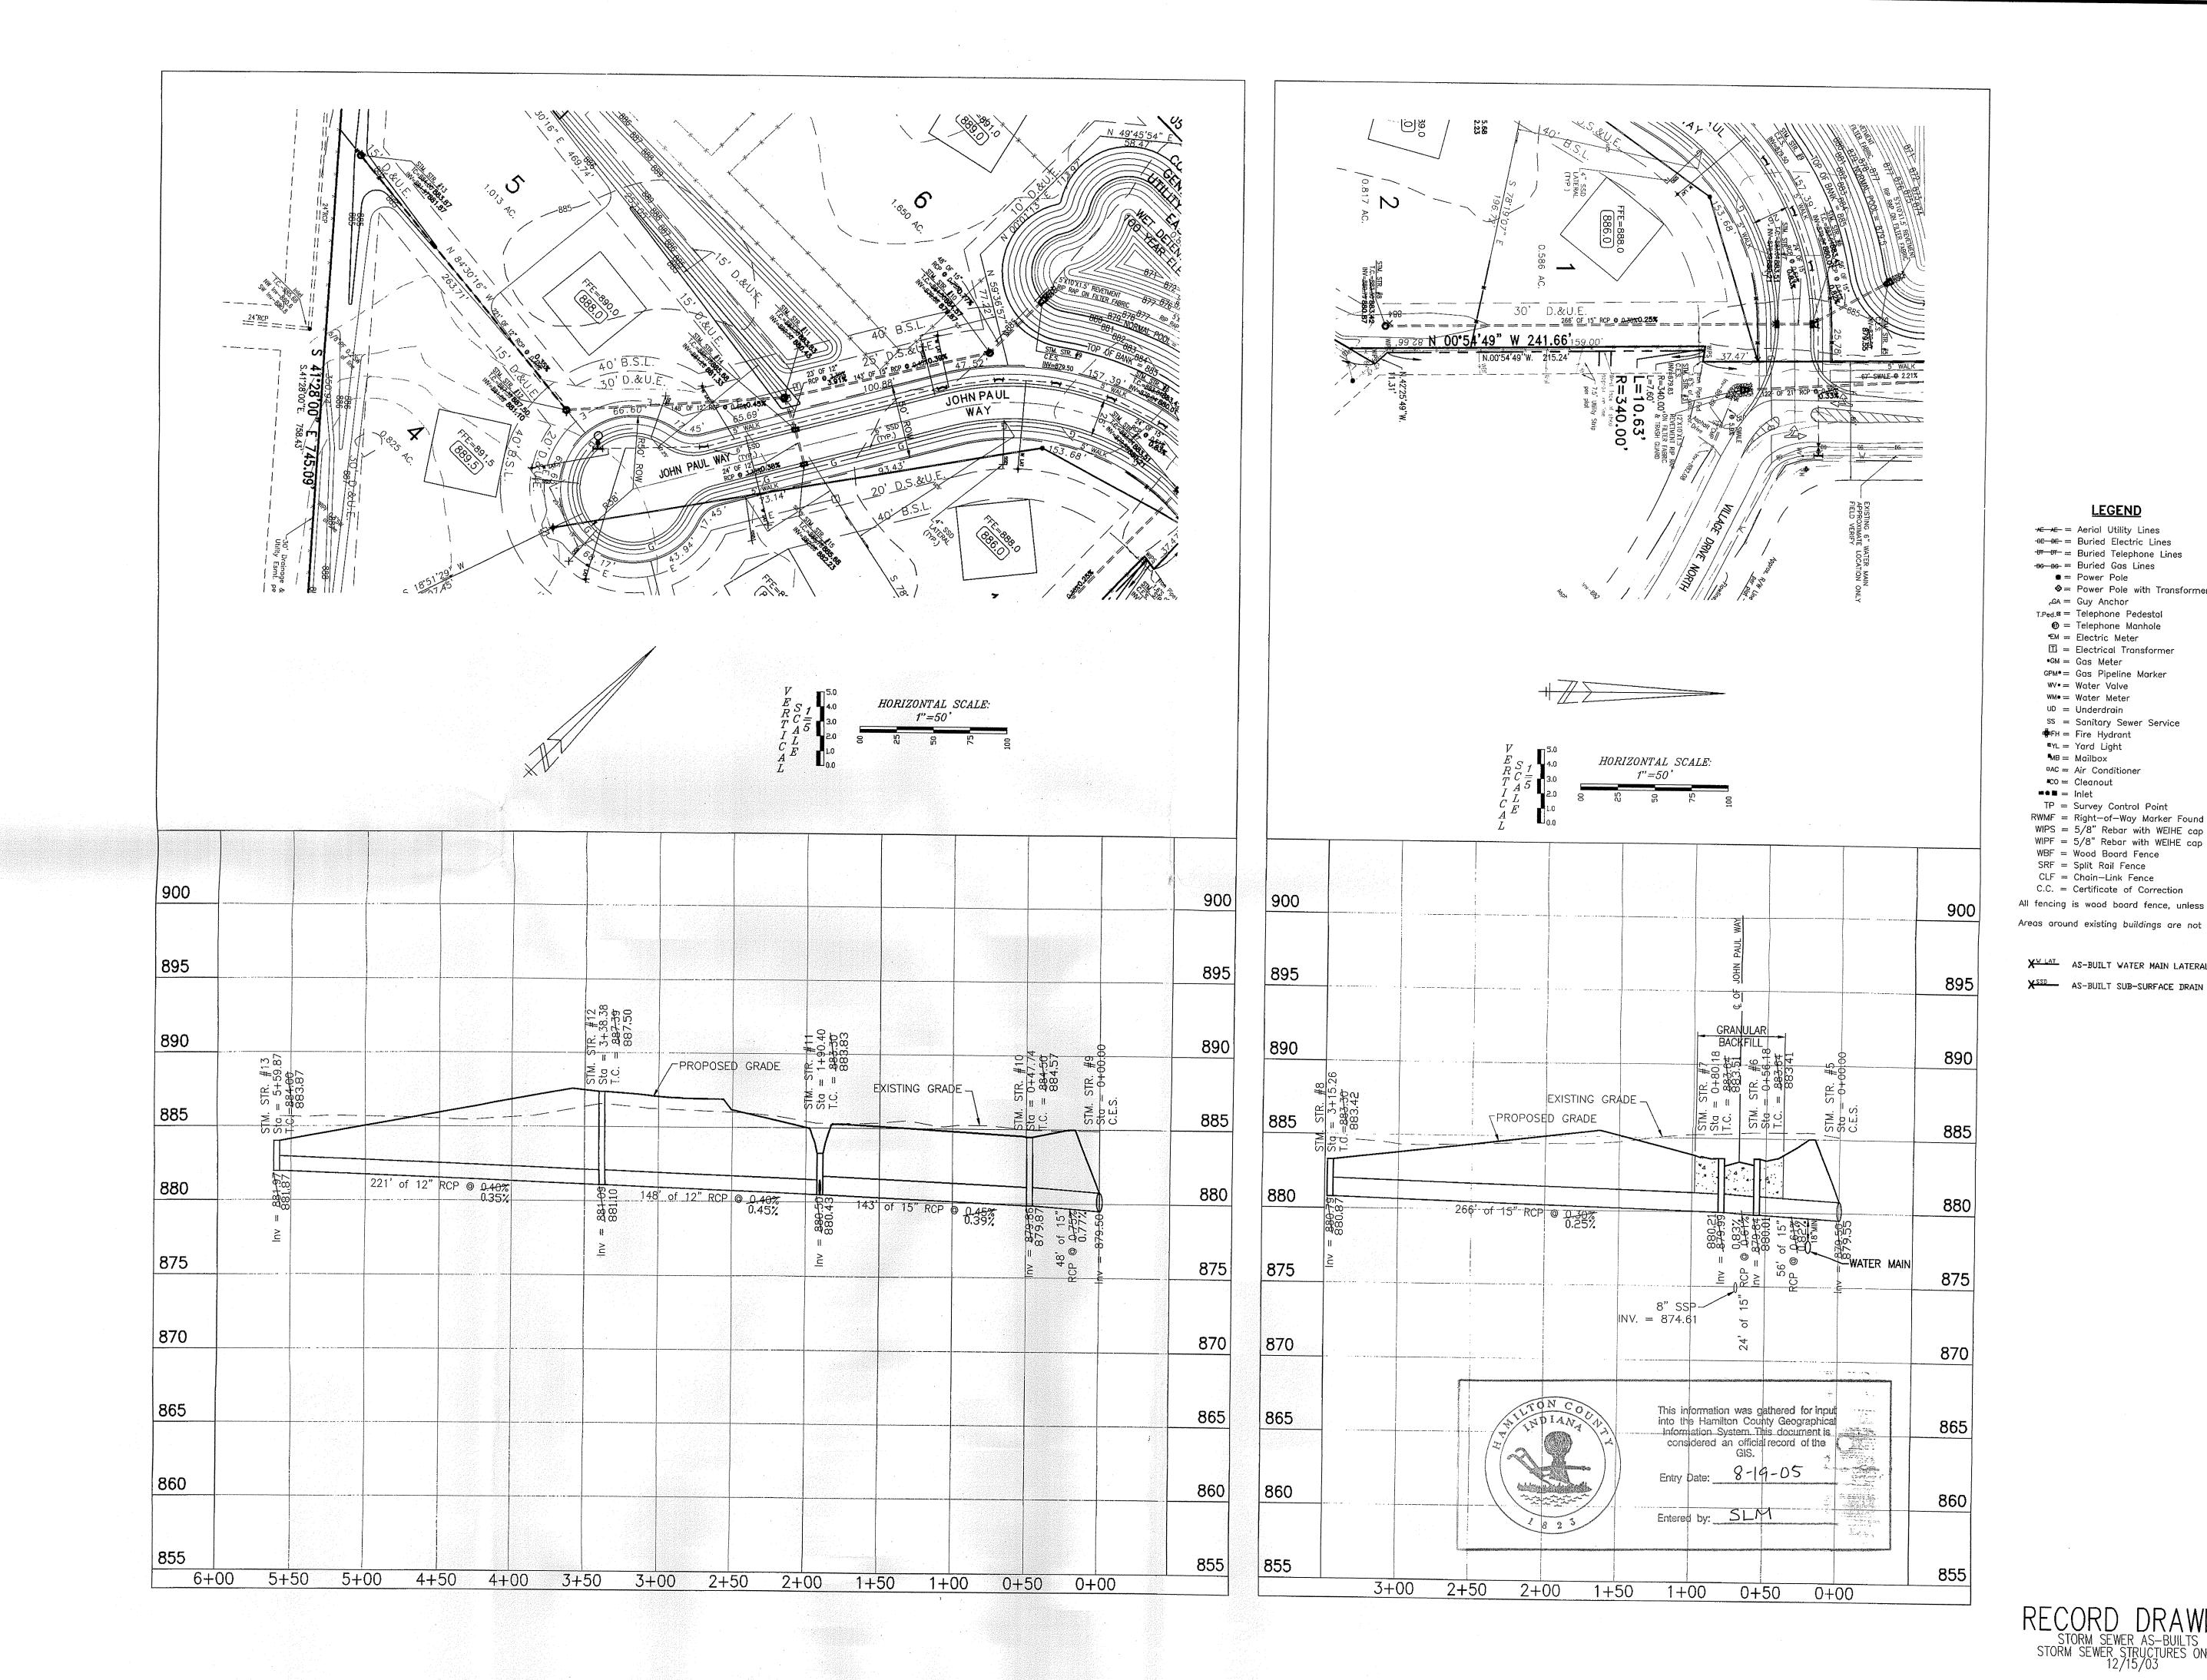

**LEGEND** 

AE AE = Aerial Utility Lines
OE DE = Buried Electric Lines ਲਾ ਲਾ = Buried Telephone Lines

> = Power Pole ♦= Power Pole with Transformer

GA = Guy Anchorچ T.Ped.¤ = Telephone Pedestal

 ⊕ = Telephone Manhole EM = Electric Meter

🗆 = Electrical Transformer •GM = Gas Meter

wм•= Water Meter <sup>UD</sup> = Underdrain

ss = Sanitary Sewer Service ♣FH = Fire Hydrant TYL = Yard Light

PAC = Air Conditioner **\***C0 = Cleanout TP = Survey Control Point

RWMF = Right-of-Way Marker Found WIPS = 5/8" Rebar with WEIHE cap set 8/14/02 WIPF = 5/8" Rebar with WEIHE cap found

C.C. = Certificate of Correction All fencing is wood board fence, unless otherwise noted.

Areas around existing buildings are not included.

X AS-BUILT WATER MAIN LATERAL

B STATE OF WOIANA ENG JAMES K. SHINNEMAN P.E. 10200.

AMERICA SHINNER

NO. 10200392

 $F_{TION}$ 

PROFILE


AND

SHEET NO.

PROJECT NO. W02-0740

This copy is from the Digital Archive of the Hamilton County Surveyor's Office; One Hamilton Co. Square, Ste. 188, Noblesville, In

LOCATION: H:\2002 LAYOUT: Storm — DATE/TIME: January PLOTTED BY: ryans

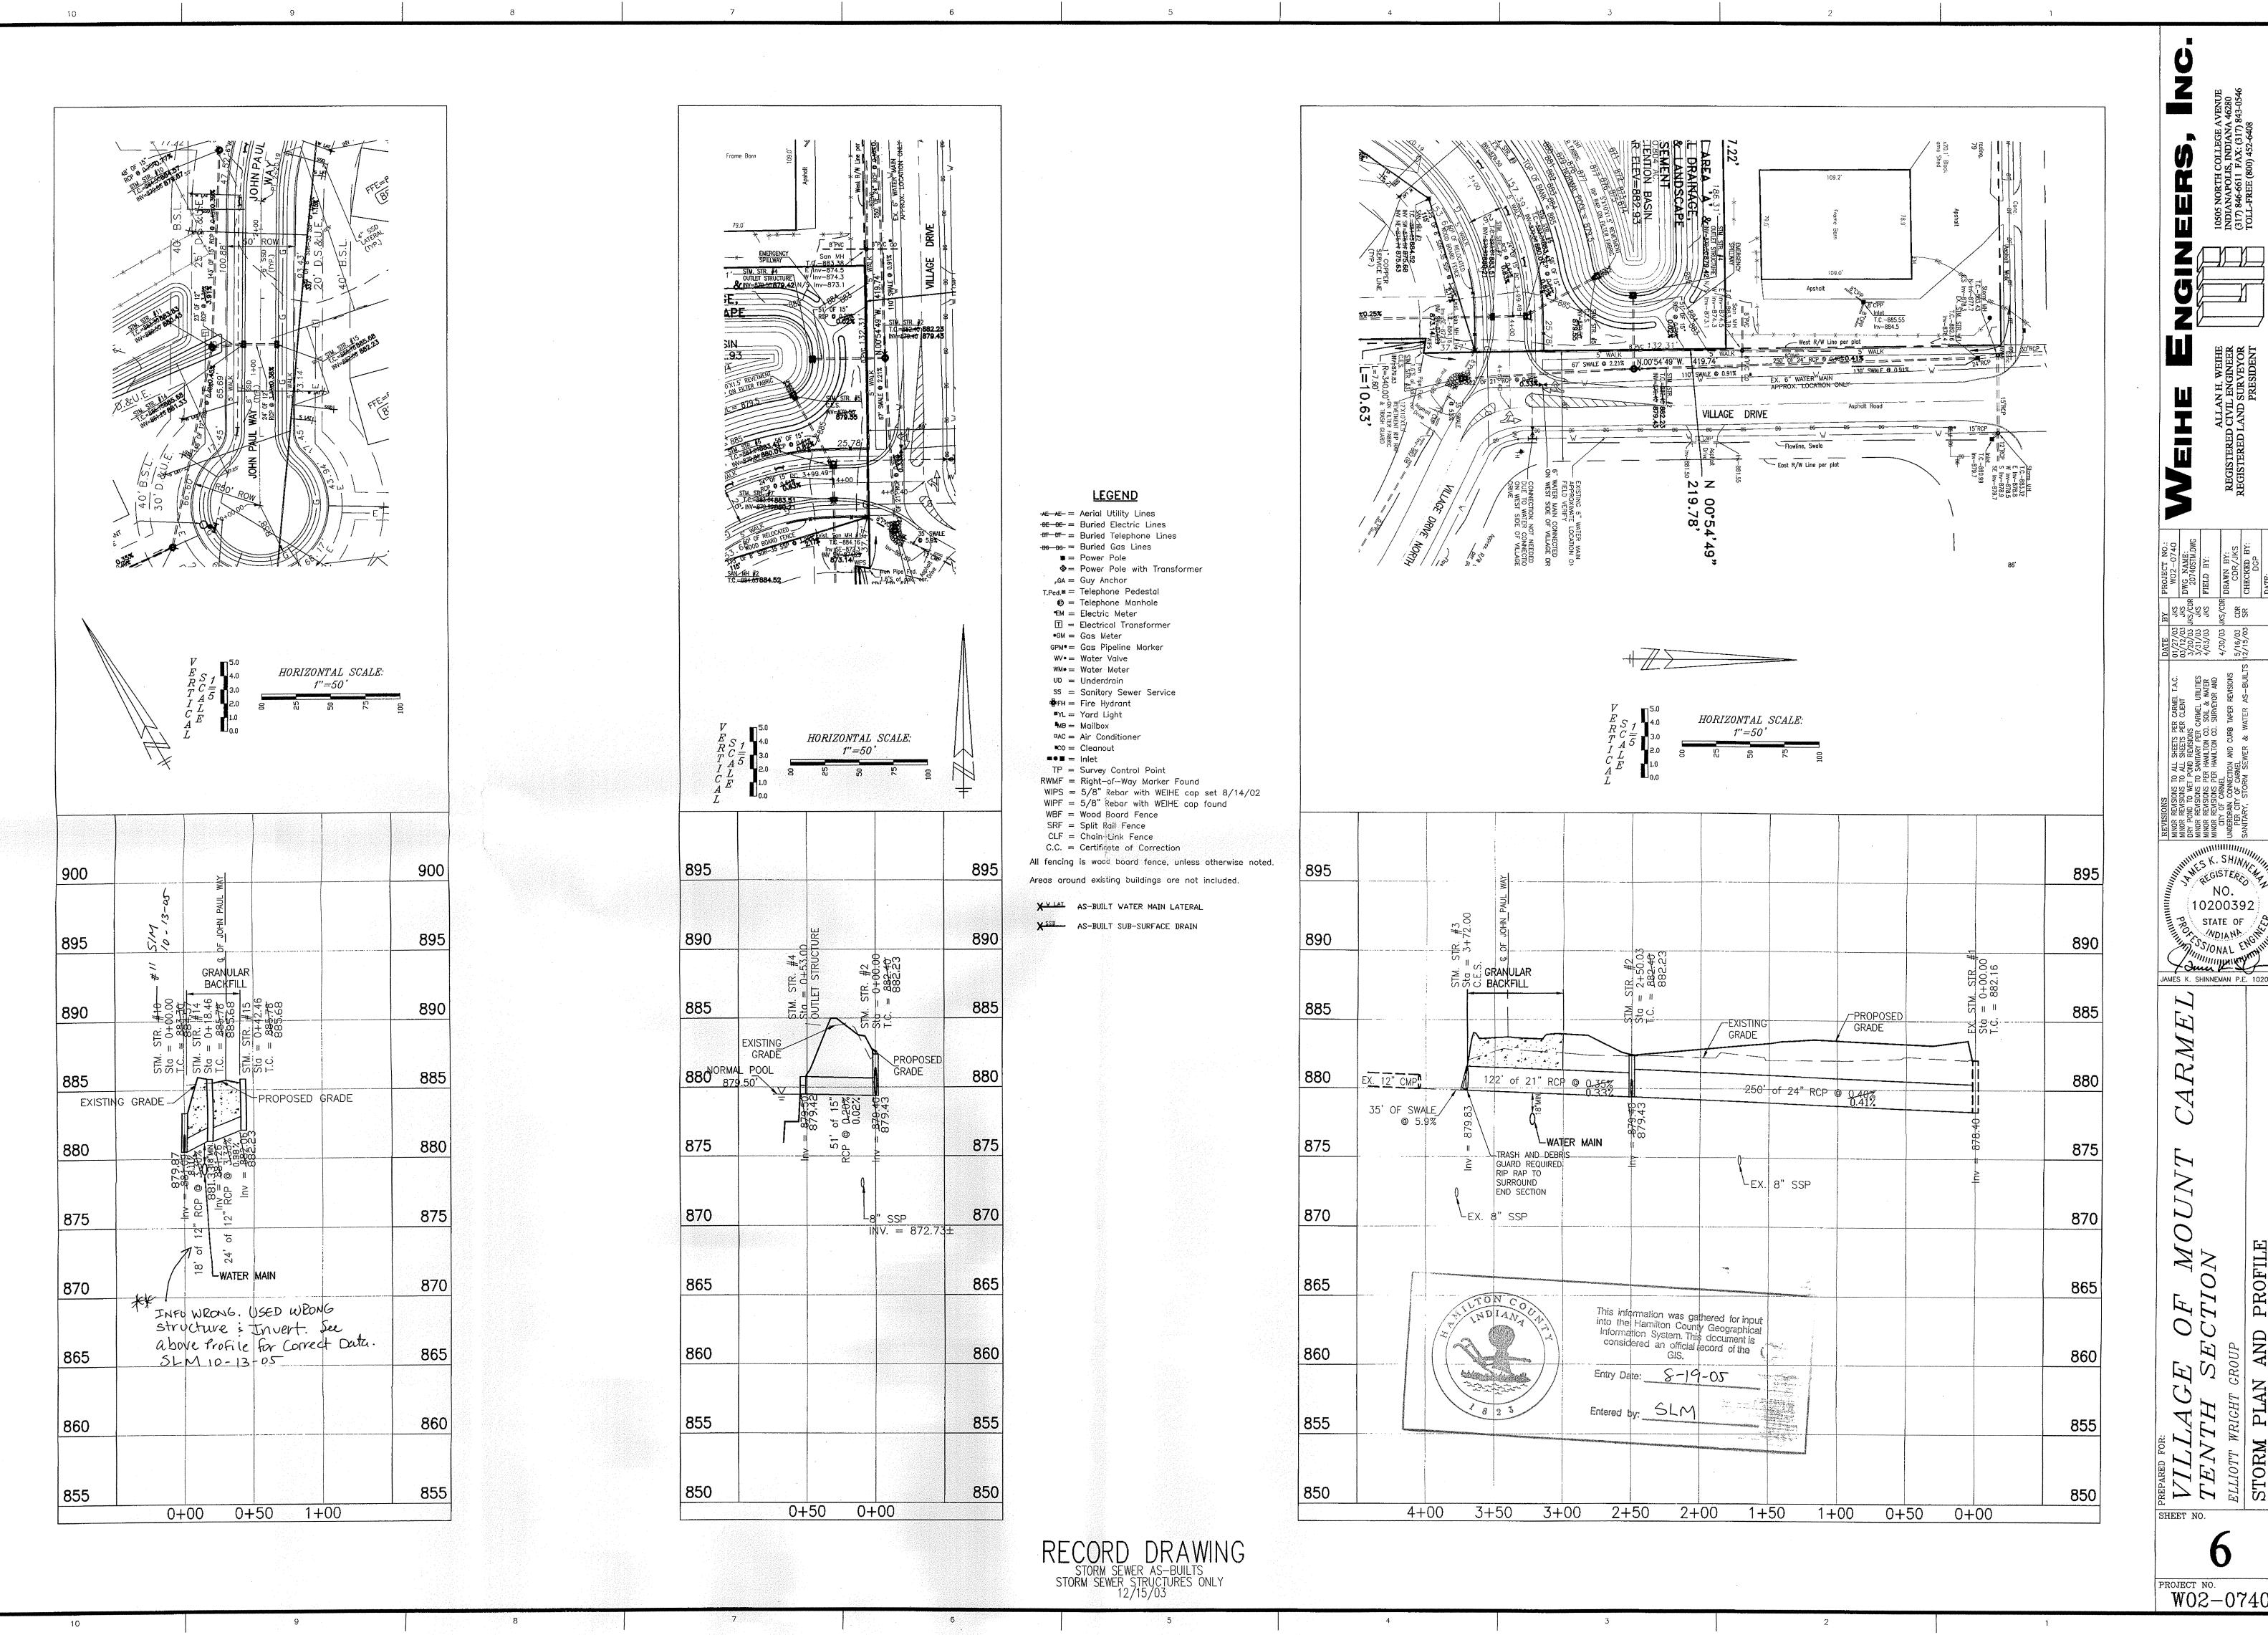

THIN A REGISTER

STATE OF WOIANA


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OF

GE I S.

W02 - 0740


NO. 10200392

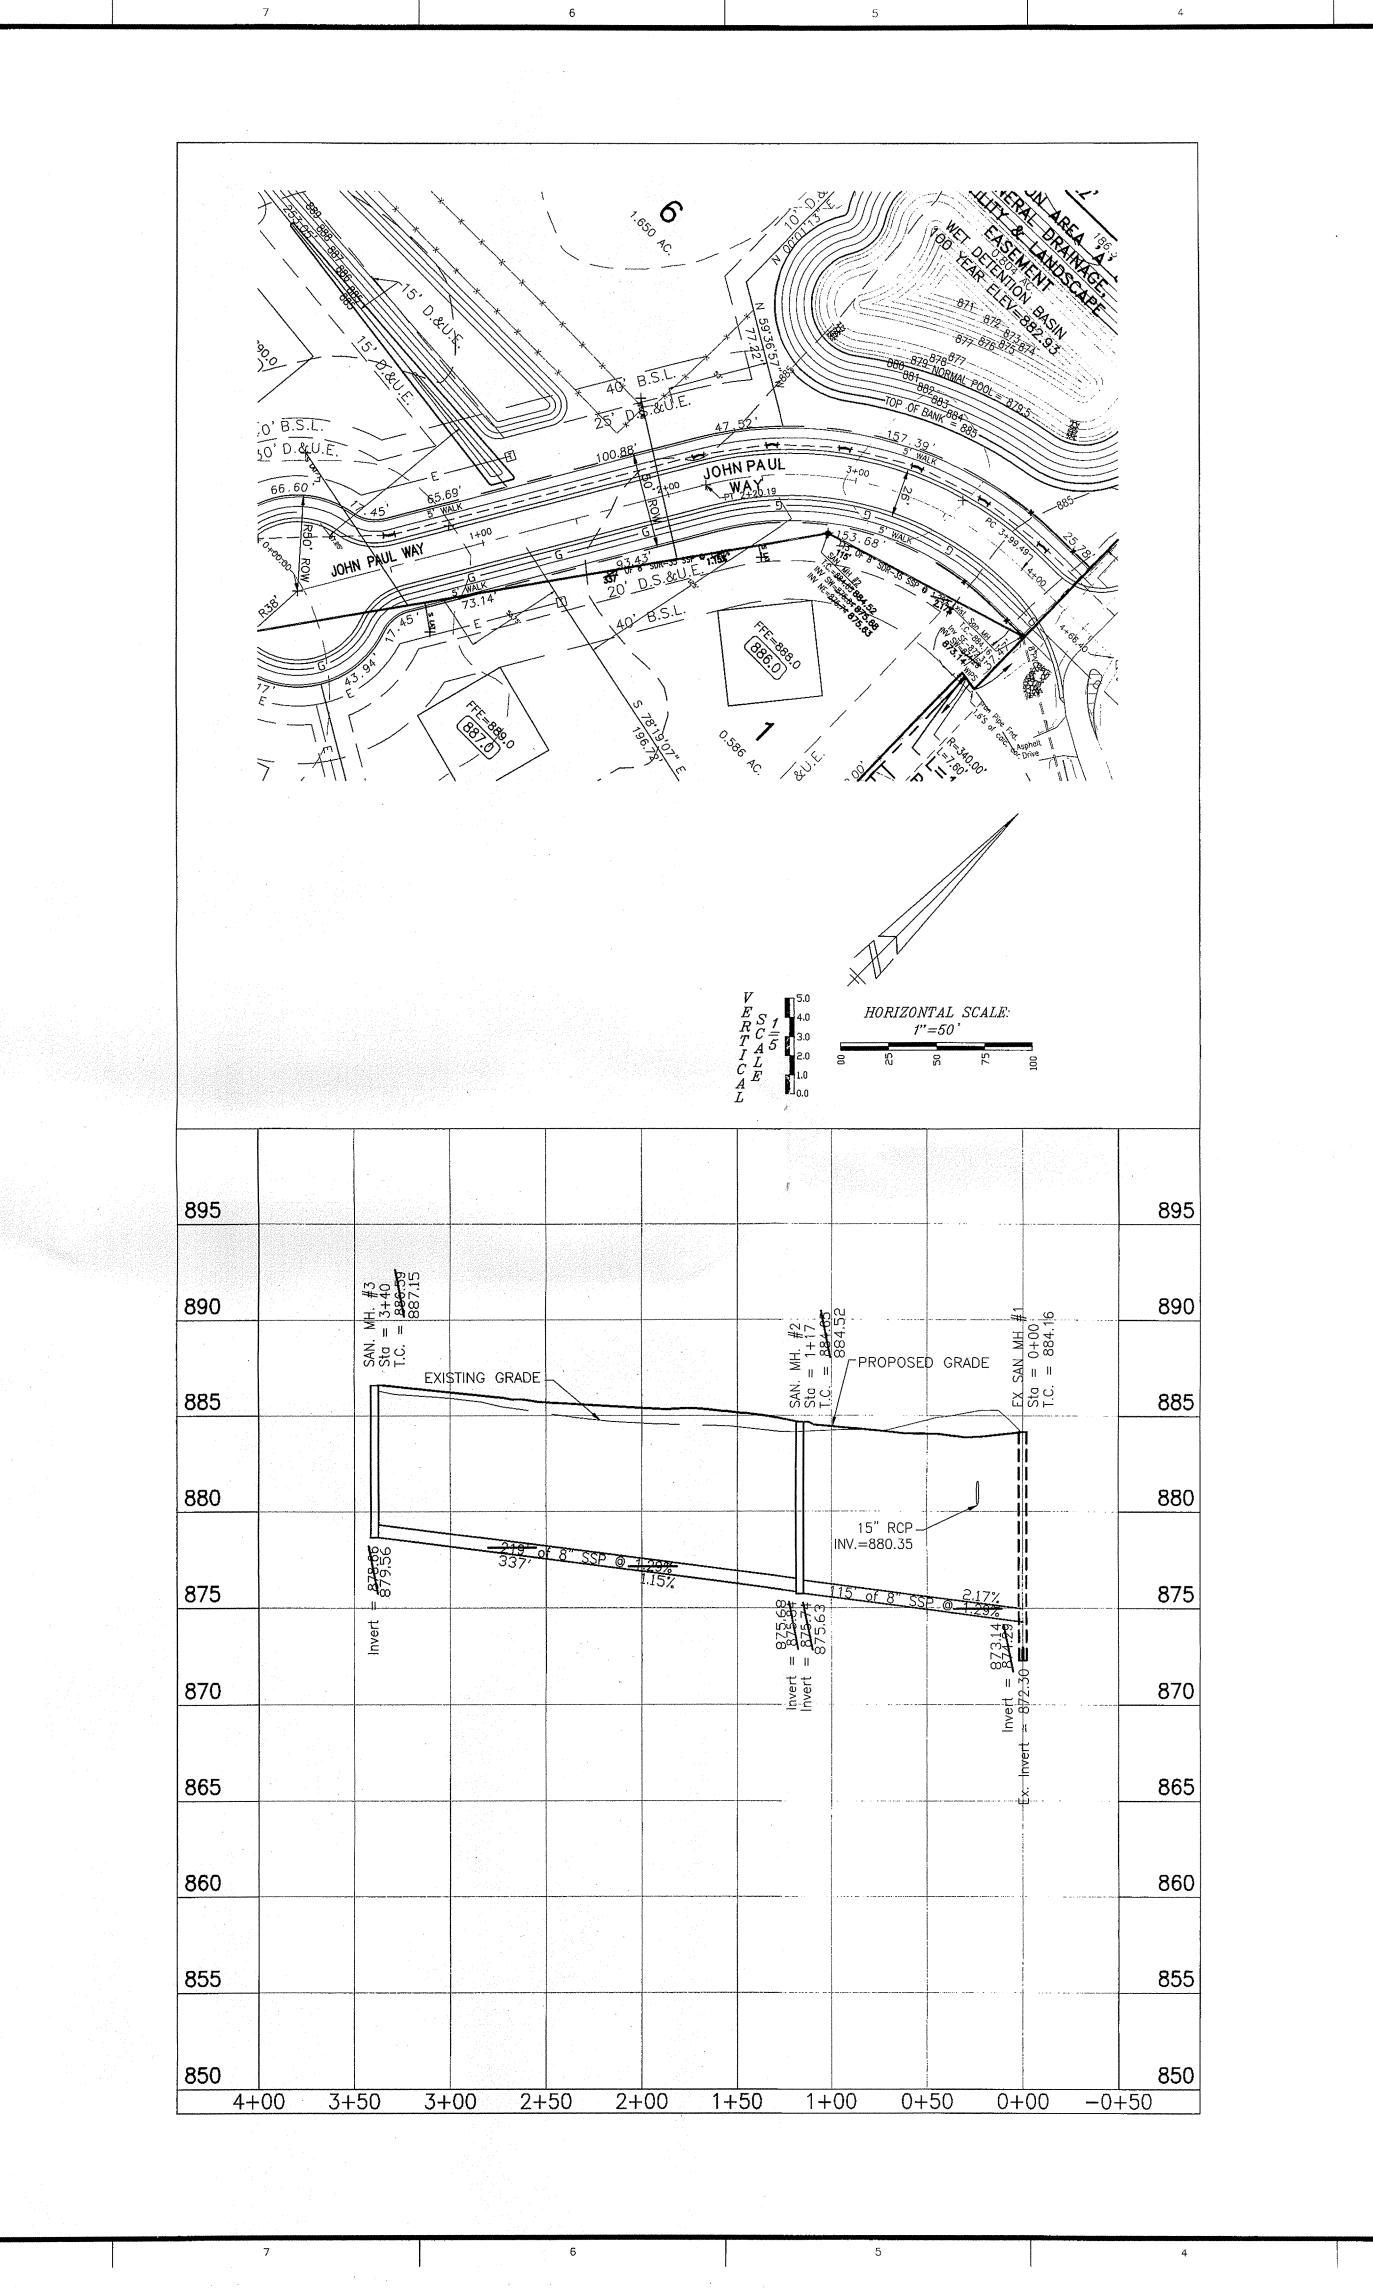

NOTE:
ALL SANITARY LATERALS WITHIN
THE RIGHT-OF-WAY ARE
REQUIRED TO HAVE FULL DEPTH
GRANULAR BACKFILL.

<b>-</b>	]	LATERA LOCATION	
STATIONING IS FROM NEAREST DOWNSTREAM MANHOLE	LOT #	NEAREST DOWNSTREAM MANHOLE	STATIONING
N N	1	2	<b>36</b> 38′
ટ્રેં∑	6	2	. <b>84</b> * 80'
E N	2	2	2 <del>09</del> 215'
교원	5	2	209 2251
STS	3	2	223 338'
Ź₹	4	2	223 338'
22			
TY			
U)			

X S LAT AS-BUILT SANITARY LATERAL

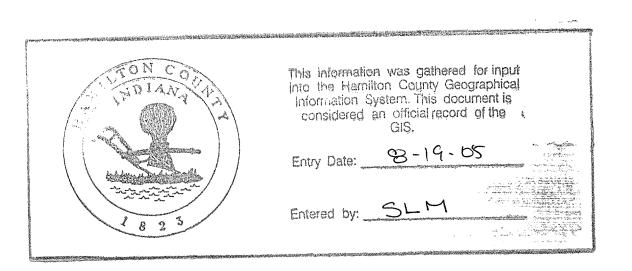


RECORD DRAWING


SANITARY SEWER AS-BUILTS
SANITARY SEWER STRUCTURES ONLY
12/15/03


NO. 10200392 STATE OF WOIANA JAMES K. SHINNEMAN P.E. 102003  $egin{array}{ccc} OF & MOUN \ ECTION \ \end{array}$ 

SHEET NO.


PROJECT NO. W02-0740

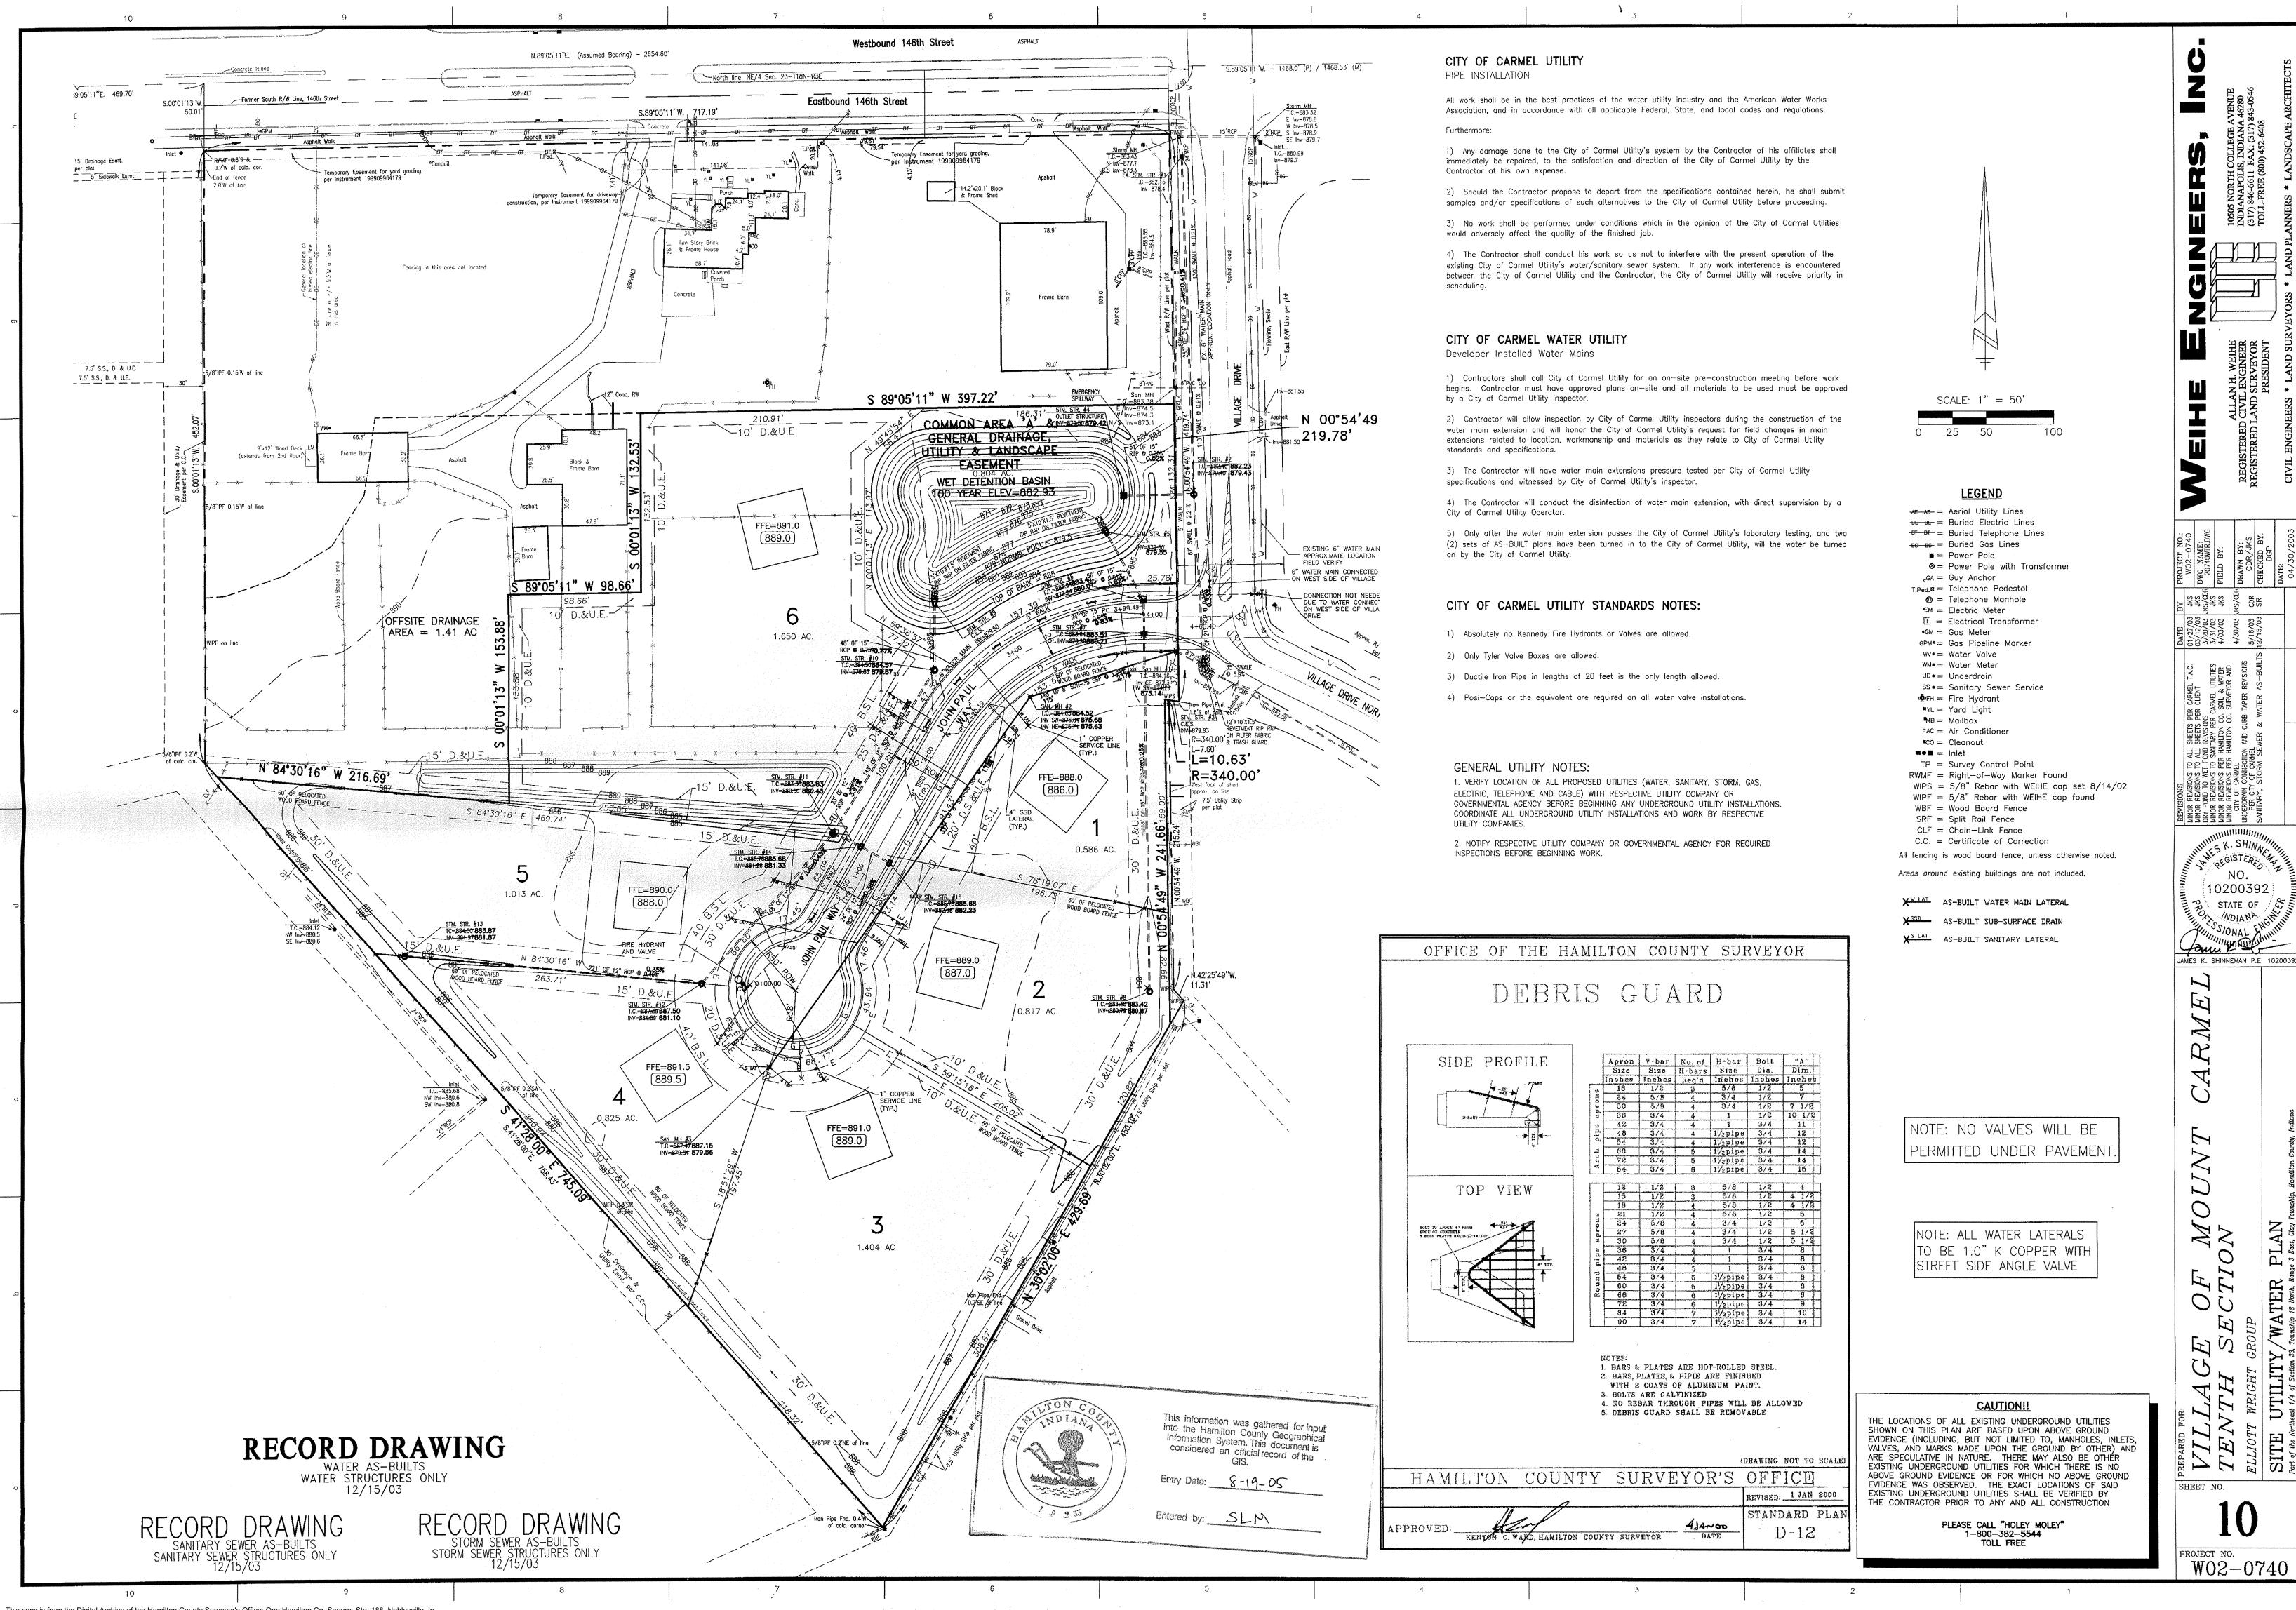

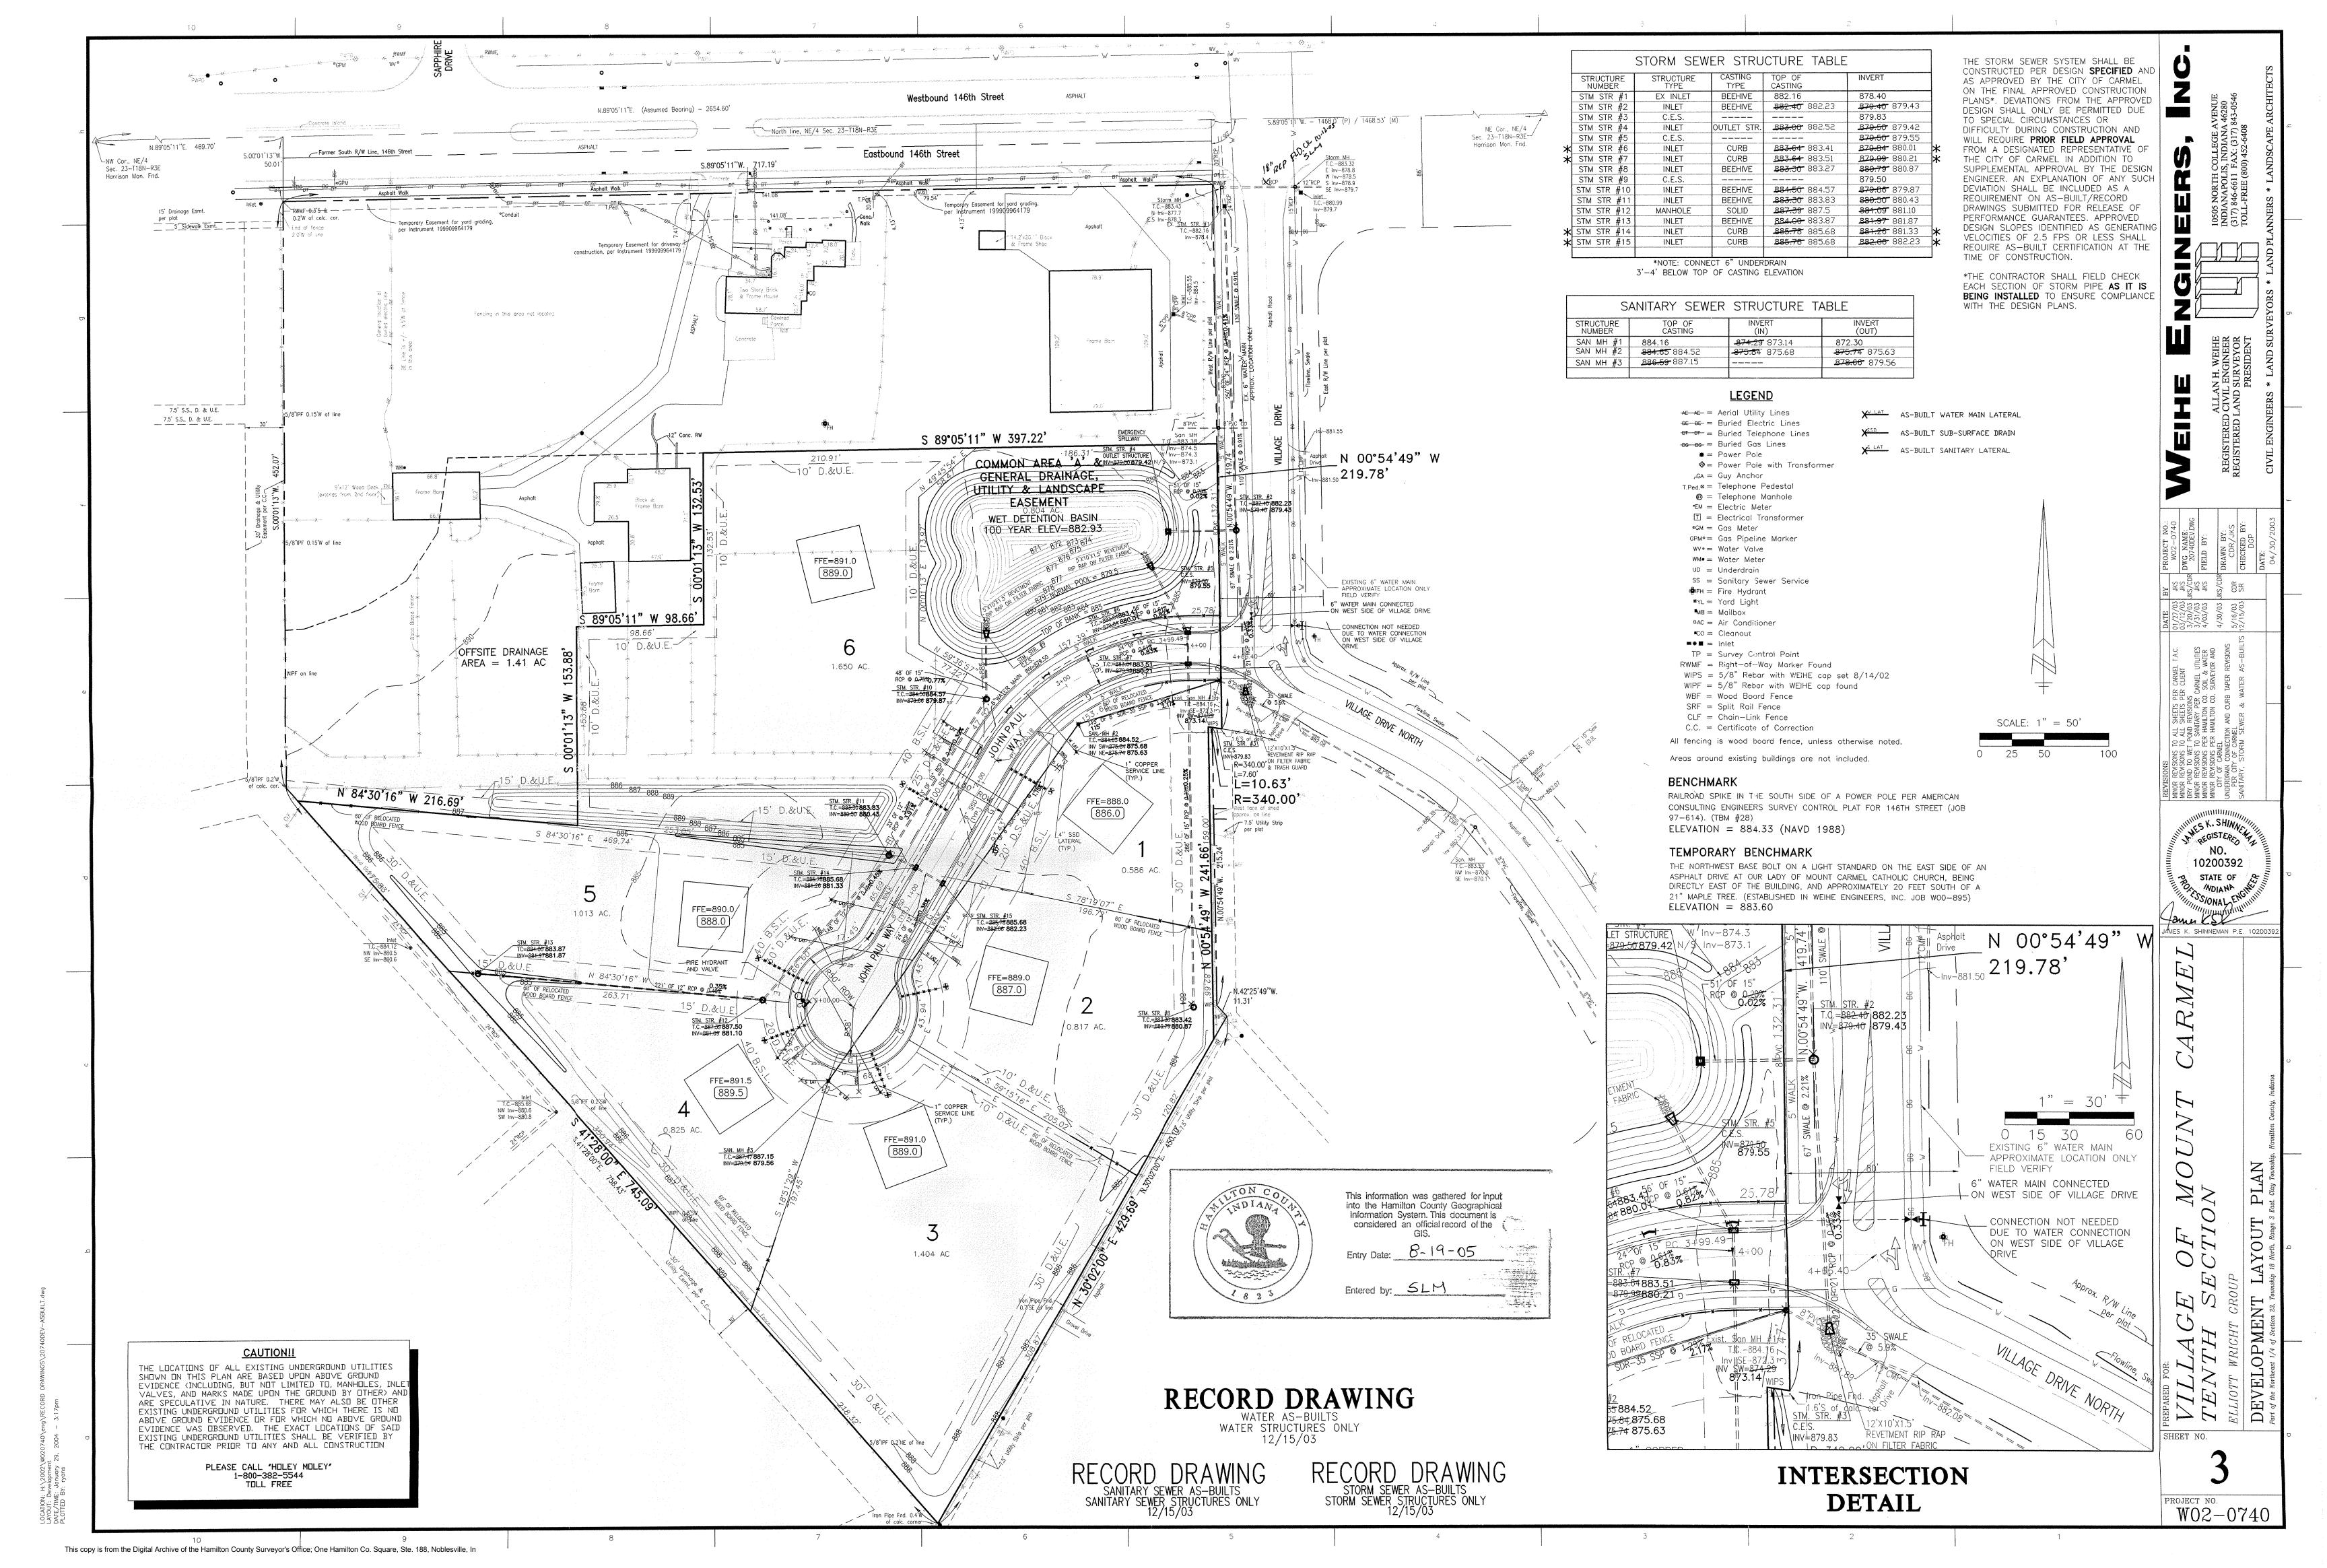

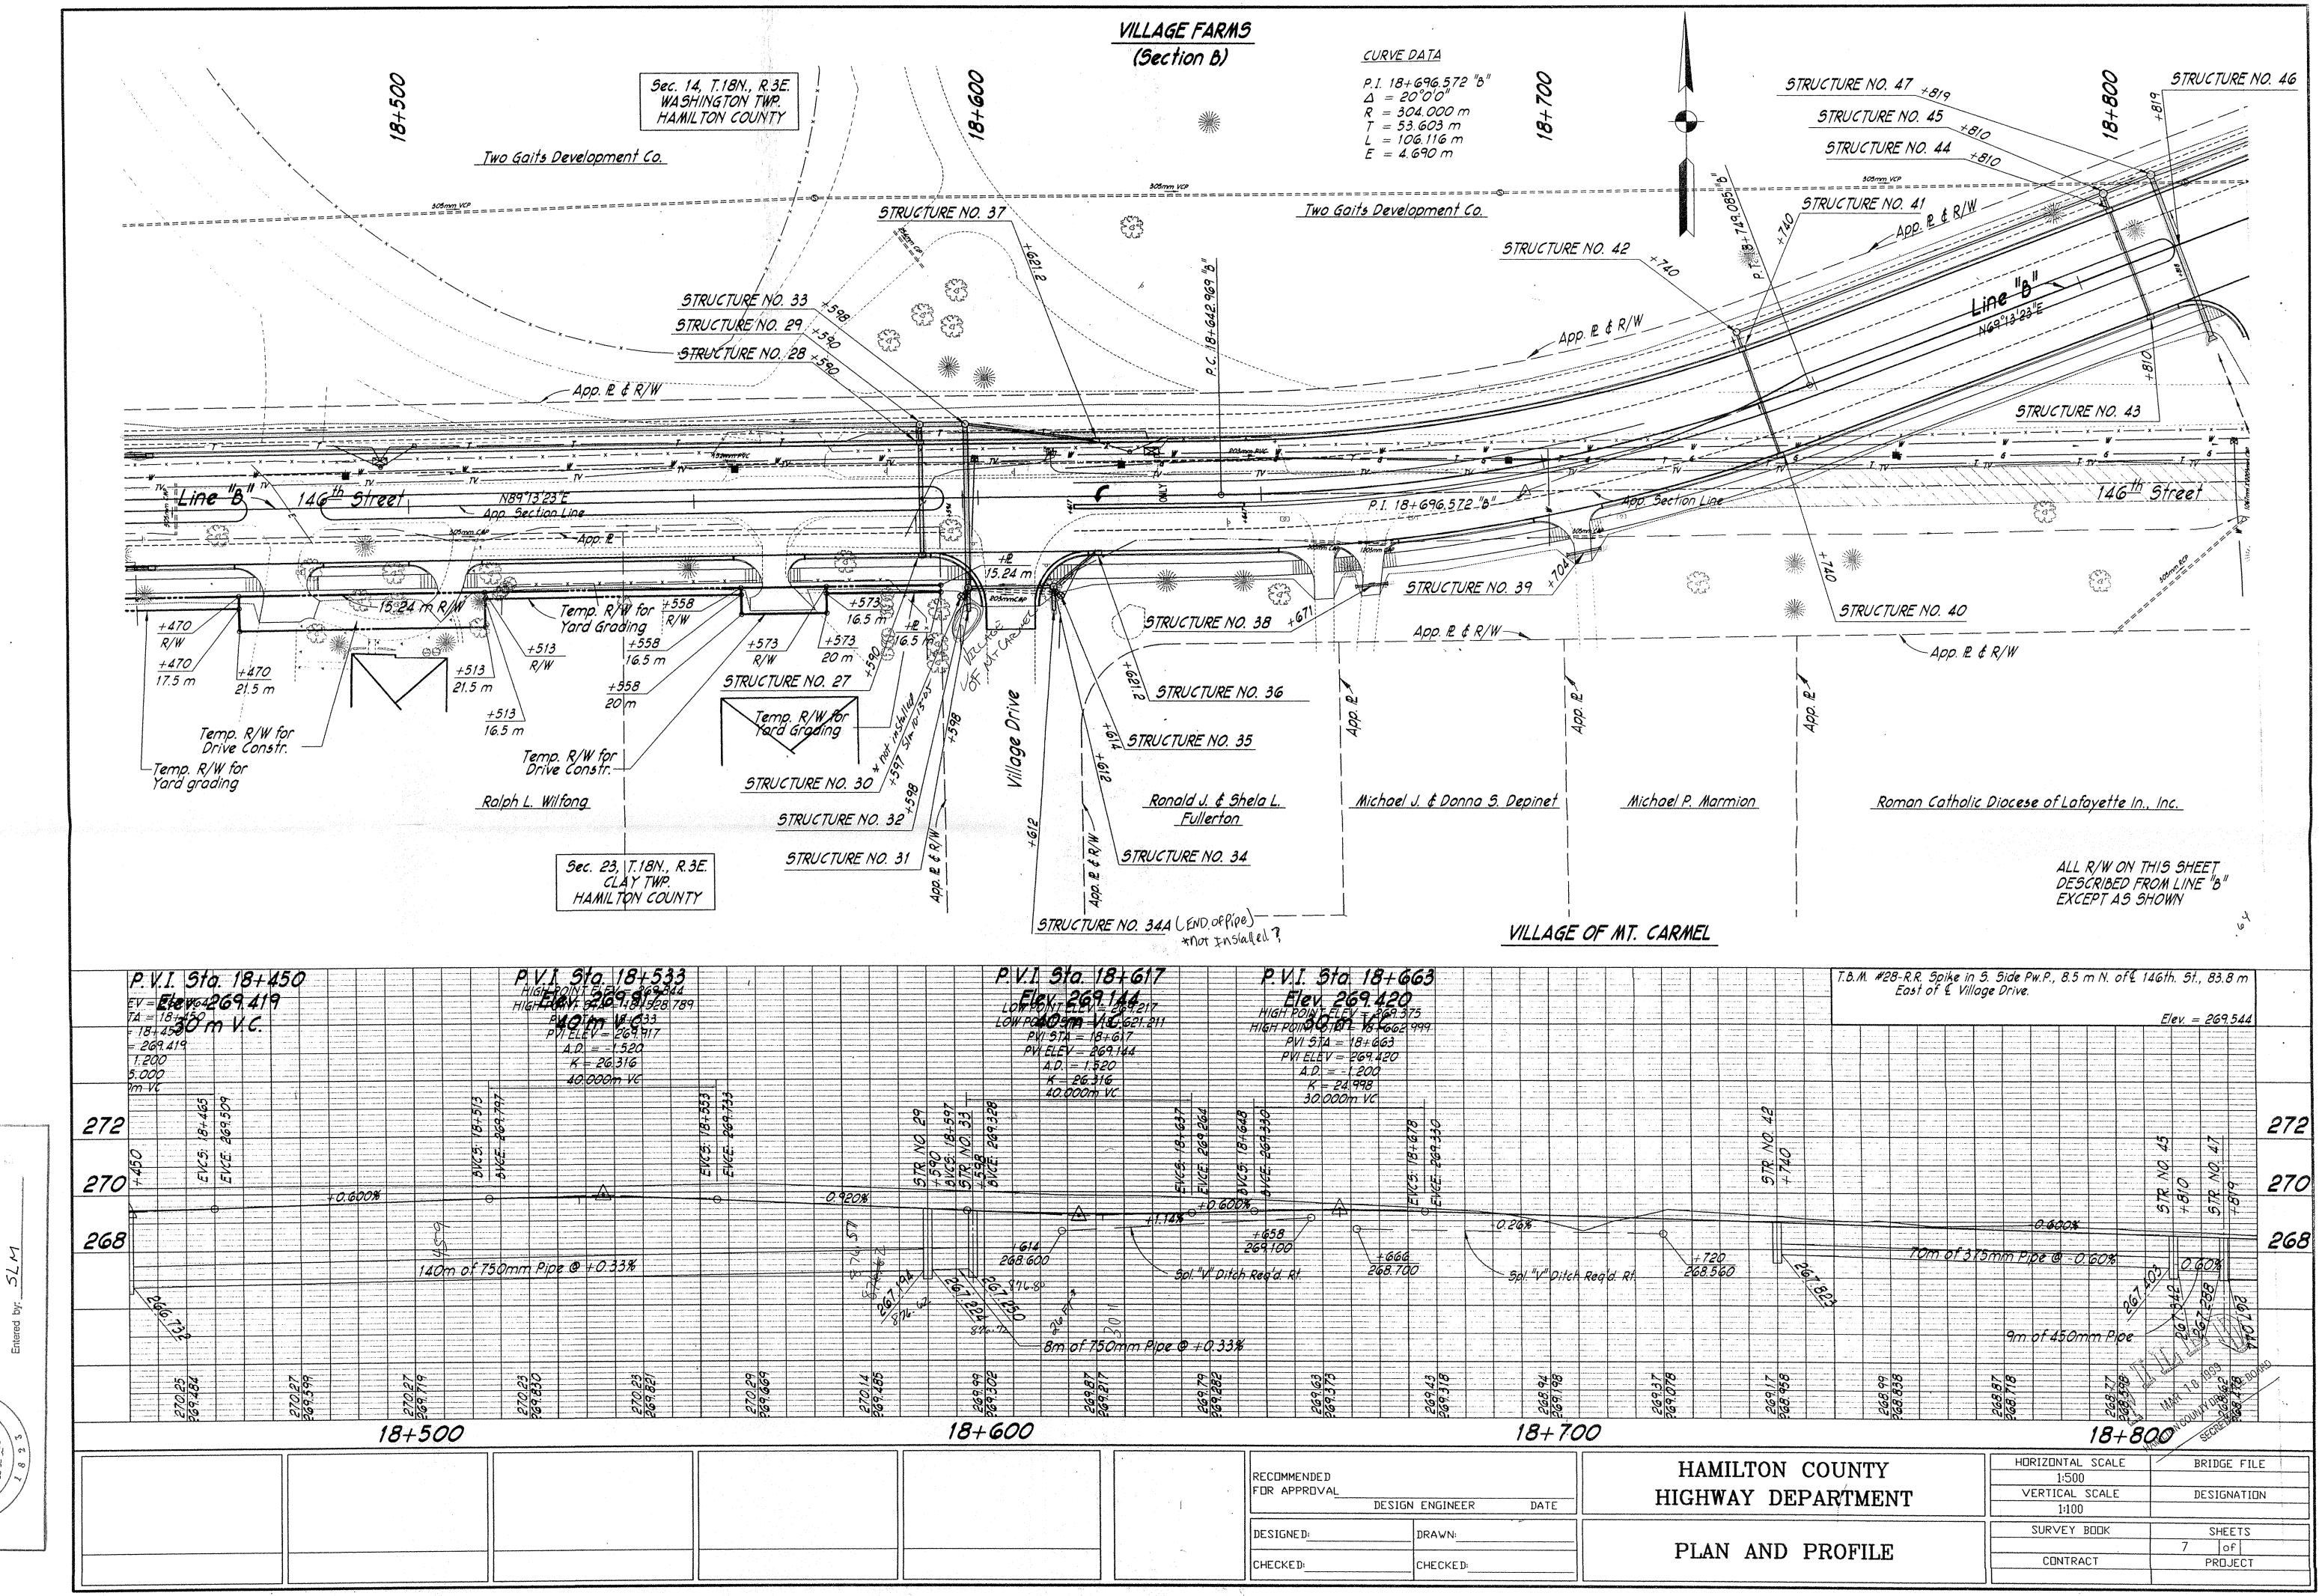

DWG FILE: J:\97\97-614\97614R11 PLOT SCALE:1:500 PLOT ORIGIN:15872.31,15064.34 SPELLCHK: EDIT DATE: 03/16/99 09:56:31 EDITED BY: WAW - S104

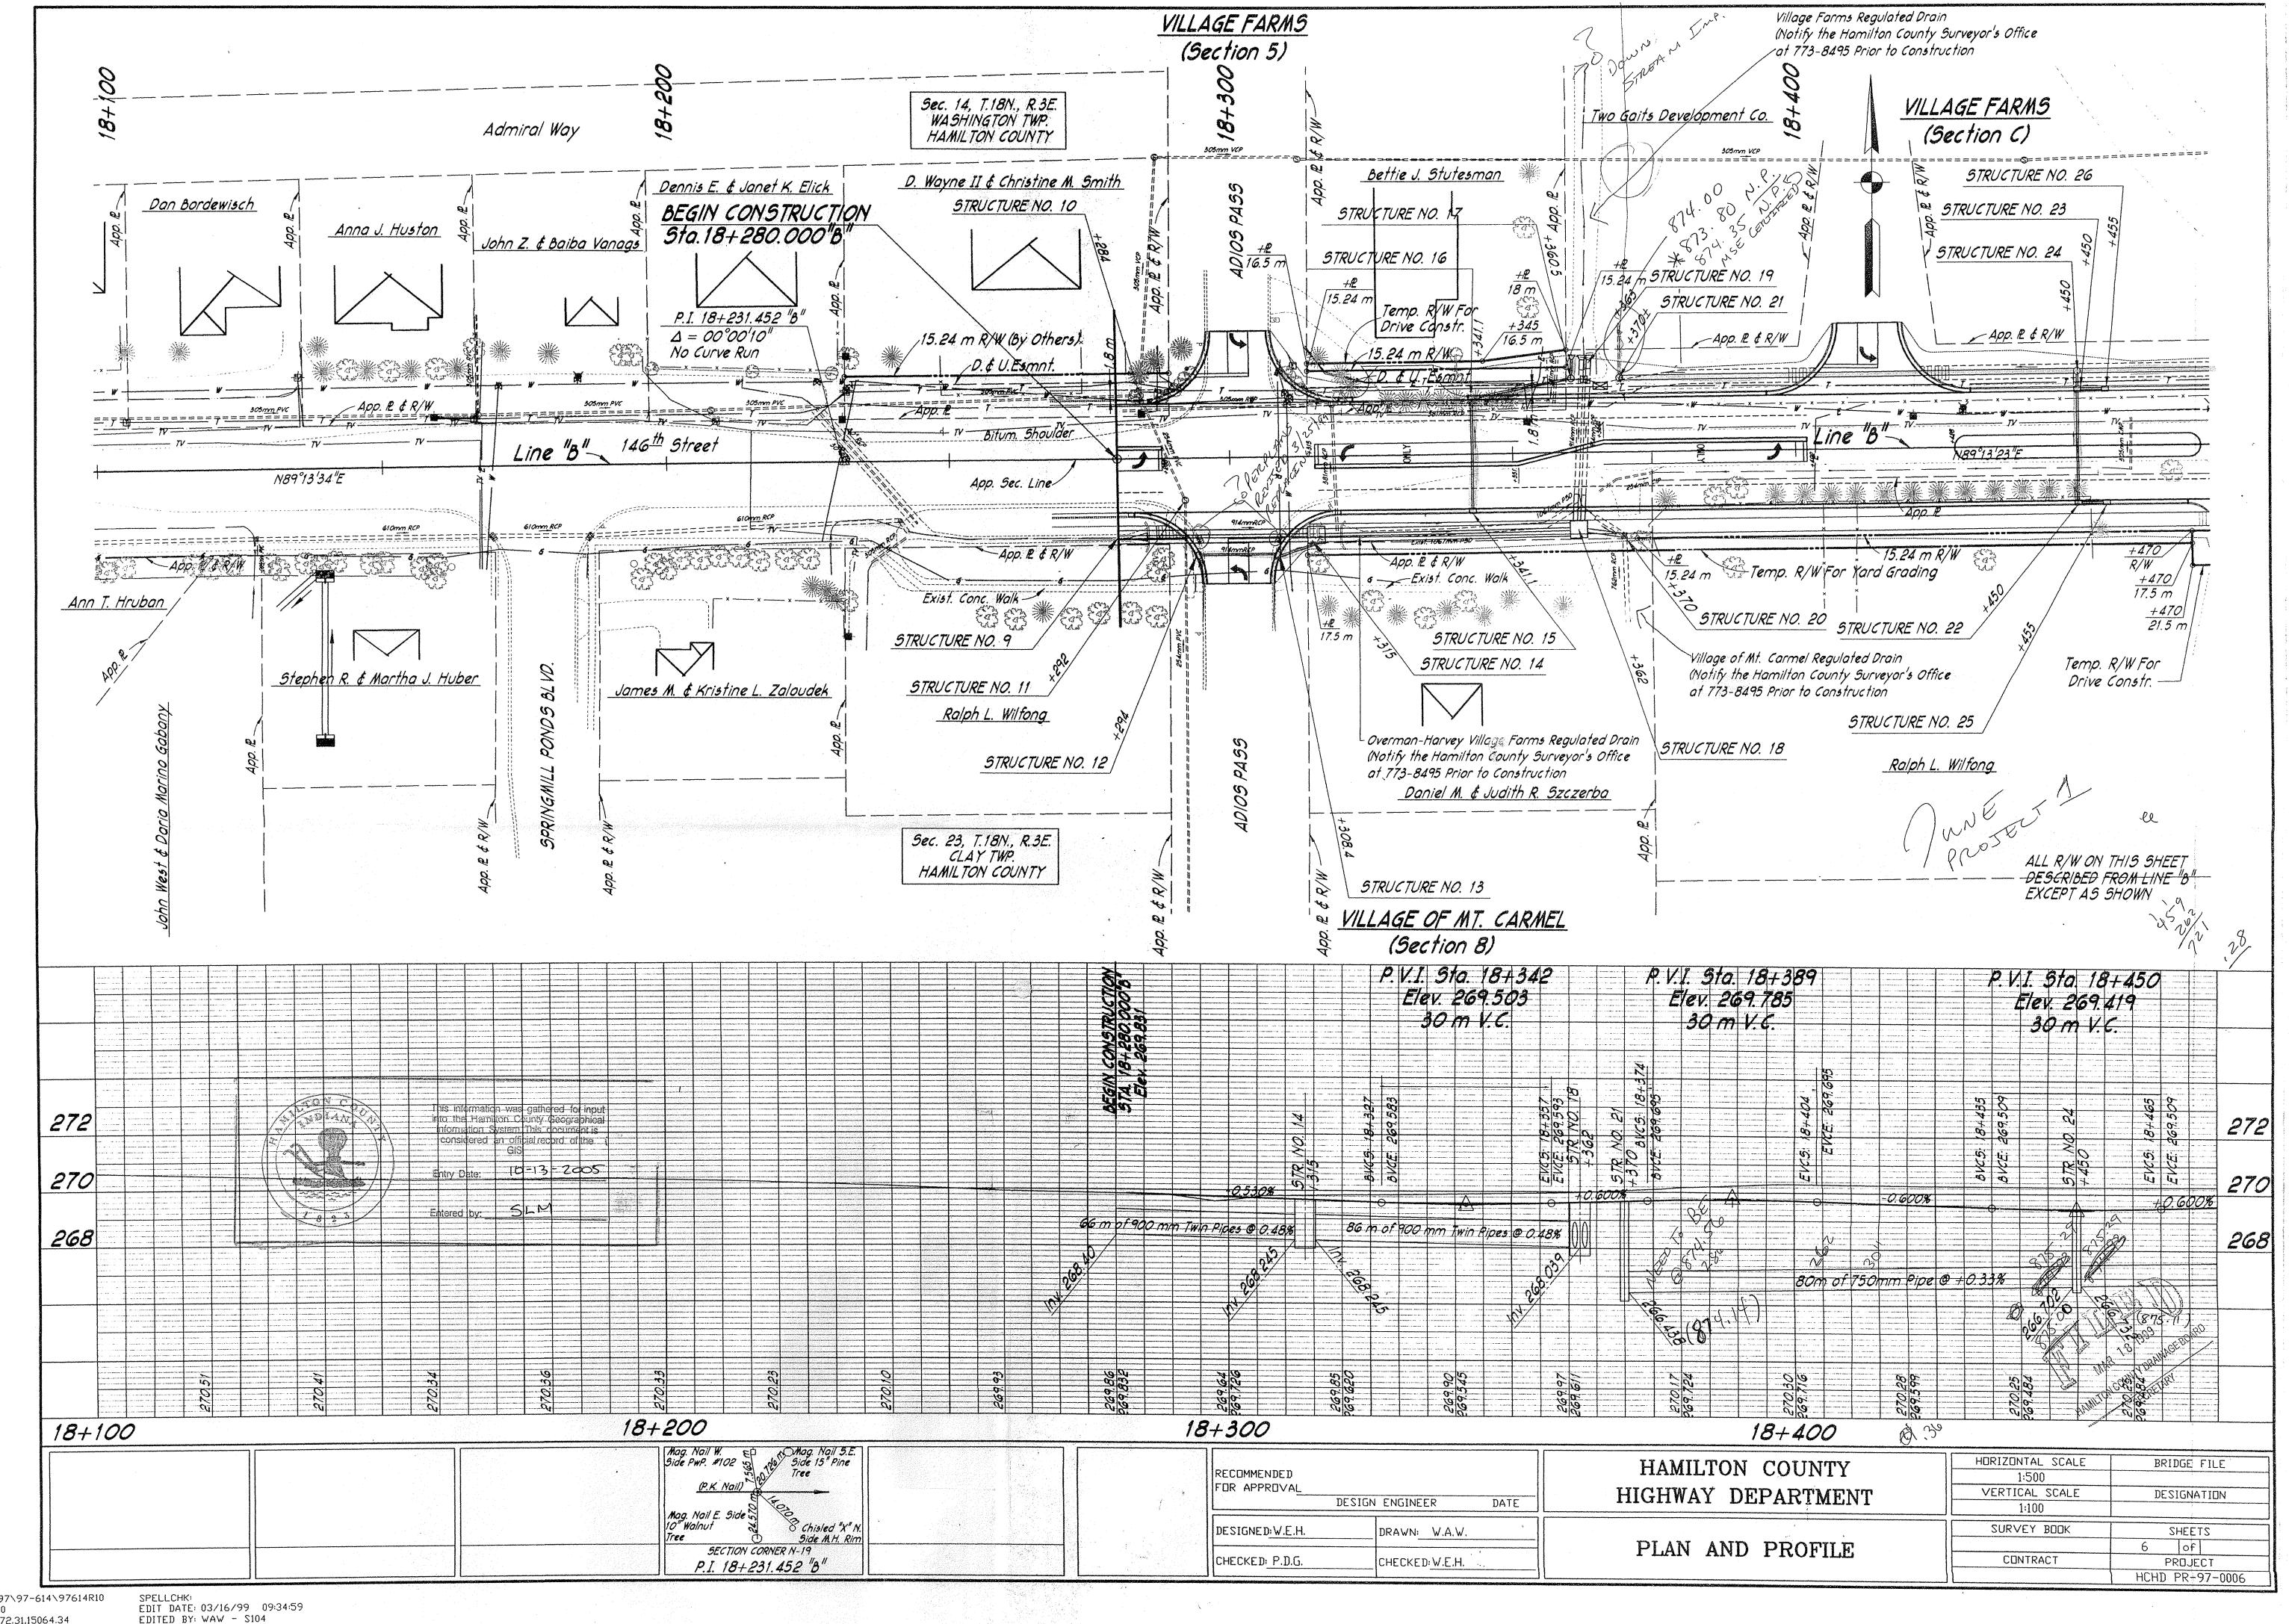

DWG FILE: J:\97\97-614\97614R10 PLOT SCALE: 1:500 PLOT ORIGIN:15872.31,15064.34

THICK	ONTRACTOR ELECTS TO USE METAL PIPE NESS AS SHOWN BELOW ARE TO BE USED.	STRUCTUF	RE DATA	* IF CONTRACTOR ELECTS TO USE METAL PIPE THICKNESS AS SHOWN BELOW ARE TO BE USED.	FEDERAL ROAD STATE PROJECT NO. FISCAL SHEET TOTAL SHEETS  5 IND. HCHD PR-97-0006 1998
DESCRIPTION SEE ST'D. SHEET "MP" FOR ACCEPTABLE TYPE OF PIPE WITH-IN EACH GROUP SEE ST'D. SHEET "MP" FOR ACCEPTABLE TYPE OF PIPE WITH-IN EACH GROUP Meters  LINE "B"  LINE "B"  DESCRIPTION FLOW SEE ST'D. SHEET "MP" FOR ACCEPTABLE TYPE OF PIPE WITH-IN EACH GROUP Meters  ELLEV.	STREAM  STREAM  CONCRETE  CLASS "A"  "B" BORROW  BACKFILL  METHOD  STEEL*  SECTION  STEEL  CONNECT TO	REMARKS	SEE ST'D. SHEET "MP" FOR ACCEPTABLE TYPE OF PIPE WITH- IN EACH GROUP  Mm  meters	SKEW  COVER  STREAM  STREAM  CONCRETE  CLASS "A"  BACKFILL  BACKFILL  METHOD  ALUM.*	A RIPRAP  SECTION  SECTION  STEEL  CONNECT TO  STRUCTURE NO.  STRUCTURE NO.
9 18+280	268.258	Twin Pipes - Remove Headwall in Place Adjust Casting to Grade Adjust Casting to Grade	LINE "B"       900       5p"I. Manhole W/Type 4       8         58 18+923.5       X 450       Pipe       32         59 18+975       X 300       Inlet Type 8-15       23	267.022 267.001 267.196 267.100 267.421 267.306	1 57
14       18+319       X       900       5p'l. M.H. W/Type 4 Casting 96       268.258         15       18+341.1       X       300       12"       Inlet Type 8-15       19.5 (A')       268.351         16       18+341.1       X       300       12"       Catch Basin Type C-15       17 ss'       268.255	268.255	Twin Pipes - Remove Headwall in Place	60 18+975 X 300 Catch Basin Type C-15 2.5  61 18+975 X 750 Sp'l. M.H. W/Type 4 Casting 57  62 19+026 X 750 Manhole Type D-451	267.306 267.294 267.170 267.022 267.303 267.170	60 61 57 61
17 18+360.5 X 300 12" Manhole Type C-4 3 10' 267.945  18 18+362 X 900 So'l. Manhole W/Type 4 11 268.039  19 18+363 X 900 4 267.916  20 18+370 X 750 Inlet in Place 7 Exist. Inv.	268.014	Twin Pipes - Connect to Existing Pipes  Twin Pipes - Outlet in Ditch - Connect to  Existing Pipes	63       19+080       X       300       Inlet Type 8-15       26         64       19+080       X       300       Catch Basin Type C-15       2         65       19+080       X       300       Manhole Type C-4       18.5	268.230 268.220 268.220 267.725	65
20       18+370       X       750       Inlet in Place       7       Exist. Inv.         21       18+370       X       Manhole in PLace (5torm)       266.438         22       18+450       X       300       12°       Inlet Type 8-15       19.5 (A°       268.255         23       18+450       X       300       12°       Catch Basin Type C-15       2       6.5°       268.159	268.159	Adjust Costing to Grade	66       19+220       X       300       Inlet Type B-15       19.5         67       19+220       X       300       Inlet Type C-15       7         68       19+220       X       300       Catch Basin Type F-7       66         69       19+285       X       300       Inlet Type 8-15       19.5	268.974 268.939	67 68 71
24 18+450 X 750 30° Manhole Type D-4 80 262° 266.702 .  25 18+455 X 300 12° Inlet Type 8-15 4 13° 268.275  26 18+455 X 300 12° Inlet Type 8-15 4 13° 268.275	266.438 21 268.255 22 268.159 23		70 19+285 X 300 Catch Basin Type C-15 2.5  71 19+285 X 375 Manhole Type C-4 79  72 19+364 X 300 Inlet Type C-15 19.5	267.752 267.740	71
27 18+590 X 300 12' Inlet Type 8-15 19.5 (4' 268.199  28 18+590 X 300 12' Catch Basin Type C-15 2 66.103  29 18+590 X 750 35' Manhole Type D-4 140 459' 267.194  30 18+597 X 300 12' Catch Basin Type E-7 1.5 5' 268.267	268.093 1 29		73         19+364         X         300         Catch Basin Type C-15         2.5           74         19+364         X         525         Manhole Type C-4         52           75         19+368         X         300         Catch Basin Type E-7         18	265.869 265.593 266.308 266.128	74 78 72
31   18+598   X   600   24"   Pipe   2   6.5   267.744   32   18+598   X   600   24"   Manhole Type D-4   28   91   267.584   33   18+598   X   750   36"   Manhole Type D-4   8   26   267.250	267.734 32 267.444 33	Seal & Cap, Upstream End of Pipe	76         19+416.3         X         300         Inlet Type 8-15         18.5           77         19+416.3         X         300         Catch Basin Type C-15         2.5           78         19+416.3         X         525         Manhole Type C-4         42           79         19+458         X         525         Manhole Type C-4         67	265.756 265.744	77 78 79 83
34 18+612 X 450 18' Manhole Type C-4 14 46' 267.828  35 18+614 X 300 12' Catch Basin Type E-7 1.5 5' 268.066  36 18+621.2 X 300 12' Catch Basin Type 8-15 9 29' 268.023	267.978 34		80         19+490         X         Manhole in Place (5an.)         .           81         19+525         X         300         Inlet Type 8-15         18.5           82         19+525         X         300         Catch Basin Type C-15	264.651 264.555 264.555 264.542	Adjust Casting to Grade  82  83
37       18+621.2       X       300       12"       Catch Basin Type B-15       22       72"       268.023         38       18+671       X       300       Pipe       6       6         39       18+704       X       300       Pipe       6       6         40       18+740       X       300       Inlet Type B-15       19.5       268.049	2	Construct Pipe Under Drive  Construct Pipe Under Drive	83       19+525       X       600       Manhole Type C-4       78         84       19+590       X       300       Inlet Type 8-15       11.5         85       19+590       X       300       Inlet Type 8-15       11.5         86       19+602.7       X       300       Inlet Type C w/Neenah       18.5		88
41       18+740       X       375       Cotch Basin Type C-15       2.5       267.951         42       18+740       X       375       Manhole Type C-4       70       267.823         43       18+810       X       300       Inlet Type 8-15       19.5       267.629	267.403 Procedura (Company) Procedura (Company		87 19+602.7 X 300 Catch Basin Type C-15  88 19+602.7 X 600 Monhole Type C-4 102	263.656 263.644	88
44       18+810       X       375       Cotch Basin Type C-15       2.5       267.531         45       18+810       X       450       Manhole Type C-4       9       267.342         46       18+819       X       750       Pipe       30       267.194         47       18+819       X       750       5p'l. M.H. W/Type 4 Casting 50       267.044	267.288 9 9 9 9 9 9 9 9 9 9 9 9 9 9 9 9 9 9		89       19+611       X       Manhole in Place (5an.)         90       19+705       X       300       Catch Basin Type B-15       18.5         91       19+705       X       300       Catch Basin Type C-15       3         92       19+705       X       750       Manhole Type D-4       75	263.440 263.344 263.344 263.329 262.175 261.425	Adjust Casting to Grade  91  92  98
48       18+831       X       300       Pipe       16       268.150         49       18+860       X       300       Inlet Type 8-15       19.5       267.329         50       18+860       X       300       Catch Basin Type C-15       8.5       267.231	267.990   Hitoturation 6   207.990   207.231   Hitoturation 6   207.231   20	Construct Pipe Under Approach	93         19+705         X         300         Catch Basin Type E-7         3.5           94         19+726         X         Manhole in Place (Tete.)           95         19+733         X         Manhole in Place (San.)         -	263.475 263.329	Adjust Costing to Grade (By Others)  Adjust Costing to Grade
52       18+910       X       375       Inlet Type 8-15       19.5       267.133         53       18+910       X       375       Catch Basin Type C-15       2.5       267.035         54       18+910       X       900       5p'l. M.H. W/Type 4 Casting       41       267.001	267.023	Connect to Existing 42" Pipe	F.B.C.C.S./P.IFULLY BITUMINOUS COATED CORRUGATED STEEL INVERT. F.B.C.C.A.A./P.IFULLY BITUMINOUS COATED CORRUGATED ALUMI PAVED INVERT. F.B.C.C.SFULLY BITUMINOUS COATED CORRUGATED STEEL C.SCORRUGATED STEEL.	INVERT.  NUM ALLOY WITH  F.B.C.C.A.A./P.IFULLY B  PAVED II  F.B.C.C.AFULLY B	TUMINOUS COATED CORRUGATED STEEL ARCH WITH PAVED STEEL ARCH WITH PAVED STEEL ARCH WITH PAVED STEEL ARCH WITH PAVED STEEL ARCH SOLUTION SECRETARY STEEL ARCH SOLUTION S
55       18+914       X       300       Inlet Type 8-15       3.5       267.150         56       18+914       X       300       Inlet Type 8-15       3.5       267.150			C.A.ACORRUGATED ALUMINUM. S.P.SSTRUCTURAL PLATE STEEL	C.S.ACORRUG C.A.ASTRUCTU	ATED STEEL ARCH. ATED ALUMINUM ARCH.

DWG FILE: K:\97\97-614\97614R06
PLOT SCALE: 1:1.000 PLOT ORIGIN: 0.00,0.00

SPELLCHK: EDIT DATE: 03/17/99 09:40:52 EDITED BY: RCM - S103